

Niagara-On-The-Lake

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Report: MHC-21-007 Committee Date: March 09, 2021

Report To: Municipal Heritage Committee

Subject: 135 Queen Street

Fulfilment of Conditions for Heritage Permit H-18-023

1. RECOMMENDATION

It is respectfully recommended that:

- 1.1 Condition #3 of Heritage Permit H-18-023 for 135 Queen Street, pertaining to final approval of the water fountain, be considered satisfied by the Municipal Heritage Committee, and the water fountain be designed substantially in accordance with the designs submitted in **Appendix A**; and
- 1.2 Condition #4 of Heritage Permit H-18-023 for 135 Queen Street, pertaining to the provision of additional trees on the Landscape Plan, be considered satisfied by the Municipal Heritage Committee as per the approved landscape plan in H-18-023 (see **Appendix B**).

2. PURPOSE / PROPOSAL

The purpose of this report is to provide a recommendation to the Municipal Heritage Committee (the "MHC") regarding the fulfillment of conditions for Heritage Permit H-18-023 for the commercial property at 135 Queen Street.

3. BACKGROUND

3.1 Site Description

The subject property municipally addressed as 135 Queen Street, is located on the north side of Queen Street within the commercial area of Old Town. The subject property is a deep L-shaped lot that is currently vacant.

The subject property previously contained a circa 1835 clapboard, Gothic Revival building, which was originally a dwelling and later converted to a commercial building. The 1835 structure was dismantled in 2015 as an engineer's report indicated that the post and beam structure had been substantially compromised with interior alterations. The post and beam structure has been stored off site and

is required to be reinstated within the future commercial building that will mimic the facade of the original 1835 building. The subject property also formally contained a large barn that was demolished in 2014.

3.2 Previous Applications

A Site Plan, Landscape Plan and Building Elevations were supported by the MHC and subsequently approved by Council in April 2015.

The proposed building was redesigned in 2018 in response to the uncovering of archaeological resources, which are to remain in situ on the subject property. Staff Report MHC-18-029 (attached as **Appendix C**) as reviewed on June 12, 2018 by the MHC, recommended approval of a revised Site Plan, Landscape Plan and Building Elevations. Staff and the MHC supported the revised plans subject to conditions. As a result, Heritage Permit H-18-023 was issued with the following conditions:

- 1. the door at the west building elevation of 135 Queen Street be removed, to the satisfaction of the Director of Community and Development Services:
- 2. the final capping system design for 135 Queen Street be approved to the satisfaction of the Municipal Heritage Committee;
- 3. the applicant returns to the Municipal Heritage Committee for final approval of the water fountain designs for 135 Queen Street; and
- 4. the applicant provides for additional trees on the landscaping plan internal to the site, to the satisfaction of the Municipal Heritage Committee for 135 Queen Street.
- 5. The Municipal Heritage Committee recommend that Council approve the revised building elevations for 135 Queen Street in accordance with the plans prepared by Nestico Architect Inc. dated April 27, 2018, and included in Appendix A to this report. AND that the doorcases on the new retail outlets be changed to a similar design which does not copy or mimic the doorcase of the original building to be re-erected.
- 6. That construction not move forward for 135 Queen Street until an archaeological compliance Letter is received from the Ministry of Tourism, Culture and Sport.

To date, conditions #2 and #5 have been fulfilled. The remaining conditions are outstanding. This report pertains to the fulfillment of conditions #3 and #4.

An application for Site Plan Amendment has also been submitted for the new building design and is currently being reviewed by Staff.

4. DISCUSSION / ANALYSIS

4.1 Ontario Heritage Act, R.S.O. 1990, c. O.18

The subject property is located within the business area of the Queen-Picton Heritage Conservation District (the "District"), designated under Part V of the Ontario Heritage Act (the "OHA"). Section 42 of the OHA states:

Erection, demolition, etc.

No owner of property situated in a heritage conservation district that has been designated by a municipality under this Part shall do any of the following, unless the owner obtains a permit from the municipality to do so:

- 1. Alter, or permit the alteration of, any part of the property, other than the interior of any structure or building on the property.
- 2. Erect, demolish or remove any building or structure on the property or permit the erection, demolition or removal of such a building or structure. 2005, c. 6, s. 32 (1).

The applicant has obtained a Council approved Heritage Permit that is subject to conditions, several of which are yet to be fulfilled.

4.2 Queen-Picton Heritage Conservation District Plan, 1986

Alterations to properties within the District are guided by the policies of the Queen-Picton Heritage Conservation District Plan (the "District Plan"). The District Plan does not provide policy direction on interior courtyard design or water fountains. The District Plan generally recommends that natural materials such as brick and stone are utilized. The proposed material for the water fountain is concrete. Staff have no concerns with the proposed material or design of the water fountain (as shown in **Appendix A**), which will not be visible from Queen Street, but will add visual interest to the subject property's amenity area.

Section 6A.3 of the District Plan provides policy guidance for the treescape in the District. Within the commercial area, the treescape is largely located in the public boulevard and in areas where buildings are set back further from the street. The policies of the District Plan recommend that the treescape be maintained, enhanced and expanded in a manner to compliment the goals of the District Plan. Specifically, the treescape is encouraged to screen parking lots and other discordant features.

Staff Report MHC-18-029 expressed support for the revised Landscape Plan, but recommended the applicant explore options to incorporate the planting of trees internal to the site, within the courtyard, without adversely impacting the archaeological resources on the subject property. The recommendation to provide additional trees on the Landscape Plan was supported by the MHC. While the applicant has considered planting trees in planters within the courtyard, it has been indicated by the applicant that it would be challenging to incorporate substantial tree cover within the courtyard which would have any substantial impact within the streetscape. Staff recommend that the MHC support the Landscape Plan appended to Heritage Permit H-18-023 without the provision of additional trees in the courtyard, and that Condition #4 be considered satisfied.

5. STRATEGIC PLAN

Not applicable.

6. OPTIONS

Not applicable.

7. FINANCIAL IMPLICATIONS

Not applicable.

8. COMMUNICATIONS

The conditions of the Heritage Permit are required to be fulfilled prior to undertaking the approved works in Heritage Permit H-18-023.

9. CONCLUSION

Staff recommend that conditions #3 and #4 of Heritage Permit H-18-023 for 135 Queen Street pertaining to final approval of the water fountain and provision of additional trees on the Landscape Plan be supported by the Municipal Heritage Committee, and therefore be considered fulfilled.

Respectfully submitted,

Denise Horne, MA, Diploma Heritage Conservation Planner II

Mark lamarino, MCIP, RPP

Senior Planner

ATTACHMENTS








Appendix A - Fountain design.pdf Appendix B - Landscape Plan.pdf Appendix C - MHC-18-029.pdf

First Capital of Upper Canada - 1792

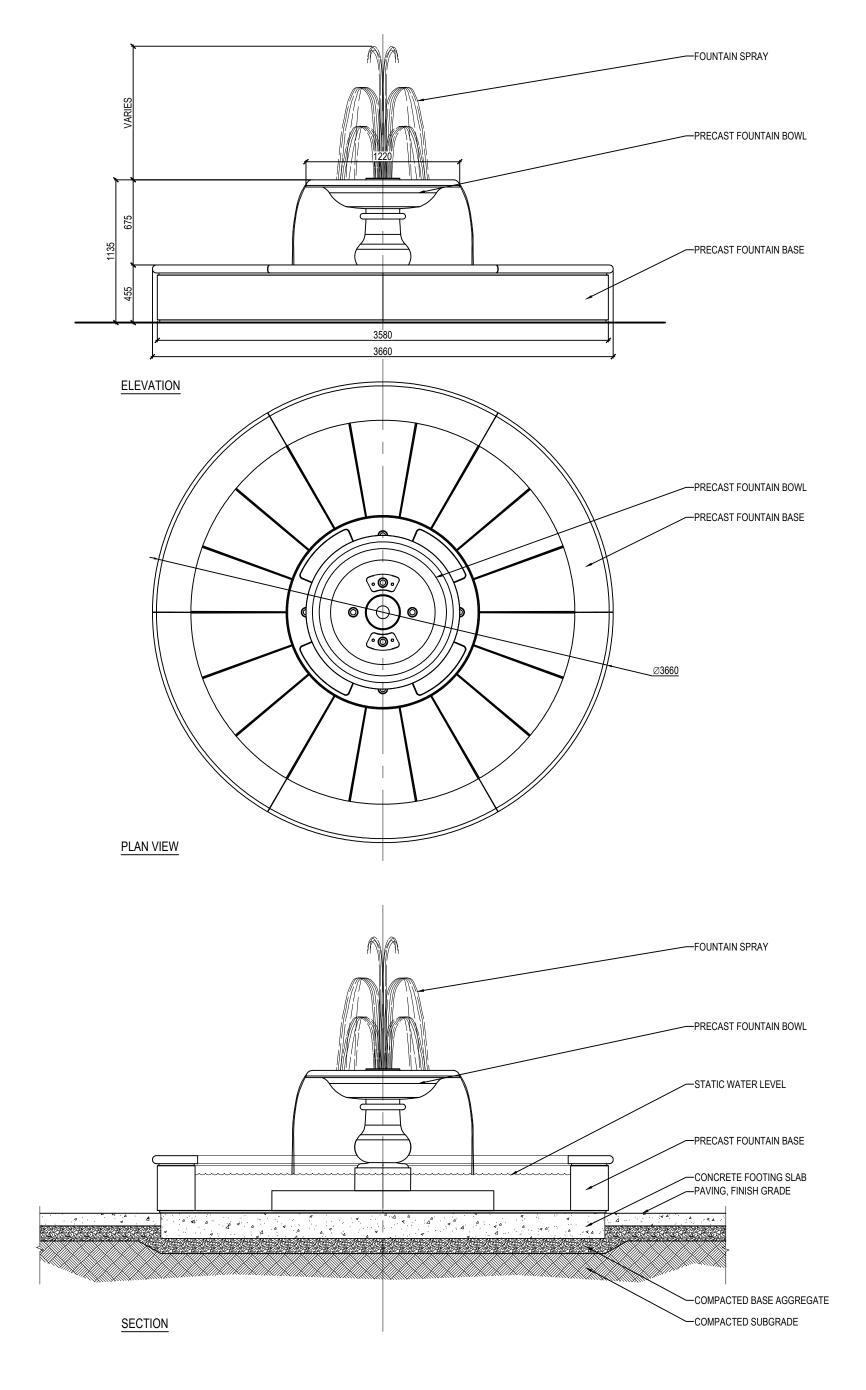

6 PLAZA FOUNTAIN DETAILS

SCALE = 1:30 P-2014-14.180-57

Roxbury Collection




Nexgen Stonewear Turnkey Fountains

Nexgen Stonewear Fountains are pre-engineered complete solutions, providing a pre-designed water feature in any landscaped or architectural installation. They are delivered as a package to any job site (exterior or interior) including everything that is needed for installation.



- Watertight, self-contained, monolithic construction
- Standard basin sizes range from 8' to 16'
- All fountains are available in any Tournesol Siteworks GFRC colors with Sandblast or Travertine textured finish
- Plumbing valves and water controls contained within the basin walls with LED lighting

The Roxbury basin's rim lends it a slightly more classic feel, but the overall shape and absence of decoration will lend itself to modern installations as well. Available in Round and Quatrefoil configurations.

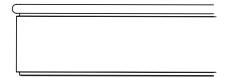

Roxbury Basin -Decorative Profile



Round Configuration -Available in 8', 10', 12' & 16' in Diameter



Quatrefoil Configuration -Available in 12' & 16' in Diameter



Center Feature - Bowl Element

Each Roxbury style Basin is paired with a center feature. Seven different bowl options are available and are proportional to the size of the fountain. Center features are also available separately for custom or built-in-place fountain designs.

Each bowl element rests on a central foundation proportionally sized to the basin. Lighting is provided for each bowl, even in multi-tiered stacks. Plaza and Crystal bowls have a drip edge to ensure a smooth, laminar stream.


Plaza Bowl - Tall, elegant pedestal with distinctive Italianate style; adds an old-world touch to any fountain installation. Each plaza bowl (depending on size) is topped with a 1/2" aerating jet or 1" blossom jet.

Crystal Bowl - Rounded top lip and tapered shape bowl; adds a simple, modern elegance to fountain environments. Available in single, double or triple tier configurations. Single crystal bowl is topped with a 1" blossom jet, double and triple bowls feature a crystal finial bubbler.

Triple bowl not available in 8' fountain sizes.

Fluted Bowl - Curved drop-lip bowl shape; expresses elegance in each of the long lines and decorative grooves of the bowl. Available in single, double or triple tier configurations. Single fluted bowl is topped with a 1" blossom jet, double and triple bowls (depending on size) feature a 1/2" aerating jet or 1" blossom jet.

Triple bowl not available in 8' fountain sizes.

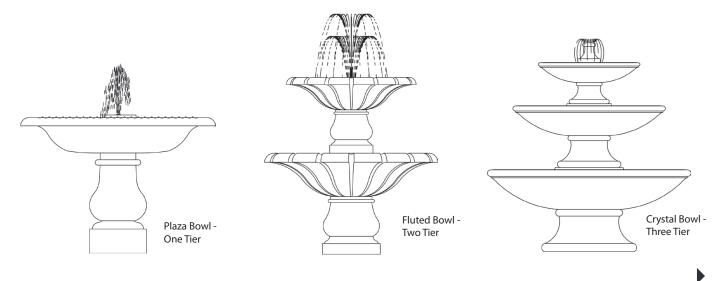



Center Feature - Water Features

Each Water Feature emerges from a central foundation proportionally sized to the basin. The foundation contains the pumps, lighting, electrical, fixturing, and controls. Lighting from the foundation accentuates the dramatic play of water.

Spray Ring - Multiple spray nozzles direct graceful arch of water around 360° from a central point. Also available as a custom option jets from the perimeter of the fountain towards the center.

Column Jets - Three spray nozzles dramatically jet water vertically into the air and are adjustable to desired water heights. Jets are centered on the foundation. Also available as a custom option, floor jets within the foundation numbers of jets on the foundation.







Roxbury Basin

Splash ratio is determined by the basic formula of distance/fall. **Distance** (D) is the measurement from the outer diameter of the center feature bowl to the inner edge of a fountain seat cap. **Fall** (F) is the measurement of the distance from where the water falls to the actual water in the bowl. For example, if D=24" and F=12," then it's 24/12 and the ratio is 2:1. Each fountain diameter and center feature combination will have a different splash ratio.


Roxbury Fountain Component Descriptions

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Pumps	Submersible pumps installed inside fountain basin; Agency approved/listed.
Lights	Sealed submersible RGB LED lights with extra cord length to allow extraction from water for service; 14V; UL listed.
Controls	125A outdoor Type 3R load center and 120V 15A programmable controller and transformer; GFIC protection for each component; UL, ETL, TUV, etc. listed.
Water Features	Adjustable flow to separate elements in water feature; built-in chemical feeder using chlorine or bromine tablets.
Plumbing	High level overflow drain; manual main drain; manual water fill; automatic water level control; feature control valves.
Documentation	Operation manual; illustrated installation instructions; specific site plan specifications; plumbing and electrical schematics; component data sheets.
Placement/Hoisting	Easy to move with removable "lifting eyes."
Composite Stone	Proprietary compound of graded stone, cement and alkaline-resistant glass fiber.





- 1. Site utilities (by others)
- 2. Utility (plumbing, electrical, drainage) connection area
- 3. Valve to control each element in water feature
- 4. Utility access panels
- 5. RGB controllable LED Lights in niche mount
- **6.** Center feature and foundation
- **7.** Direct drive submersible pumps
- 8. Floor plates
- **9.** GFRC Fountain Cap and Basin wall
- 10. Concrete slab foundation (by others)
- *Note: Timer controls away at site breaker panel.

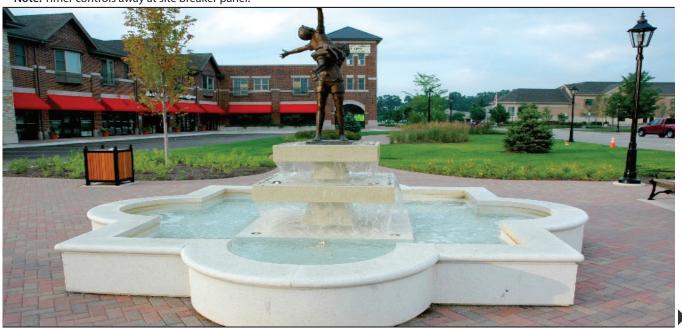



Roxbury Collection - Round & Quatrefoil

All fountains include the following: Timers for pump lights, Individual control valves for each feature, Main drain, Utility drain, Manual fill, Auto water level control, and Chlorinator.

Part. No.	Base Size	Bowl / Center Feature	Additional Information/Elements	Splash Ratio
RD08-BASIN	8' Dia., Round	Basin Only	1 Submersible Pump, 10 x 14V/6W RGB LED Lights, 1 Jet	N/A
RD08-CJ36NG	8' Dia., Round	36" Column Jet	1 Submersible Pump, 7 x 14V/6W RGB LED Lights, 3 Column Jets	N/A
RD08-SR36NG	8' Dia., Round	36" Spray Ring	1 Submersible Pump, 8 x 14V/6W RGB LED Lights, 40 x Smoothbore 1/8" Jets	N/A
RD08-PA30NG	8' Dia., Round	30" Plaza Bowl w/Aerating Jet	2 Submersible Pumps, 10 x 14V/6W RGB LED 1 Blossom 1" Jet	1.58:1
RD08-CA30NG	8' Dia., Round	30" Crystal Bowl w/Blossom Jet	2 Submersible Pumps, 10 x 14V/6W RGB LED Lights, 1 Blossom 1" Jet	2.3:1
RD08-CA3018NG	8' Dia., Round	30" + 18" Crystal Bowls w/Finial	2 Submersible Pumps, 10 x 14V/6W RGB LED Lights, 1 Finial Bubbler	2.3:1
RD08-FA30NG	8' Dia., Round	30" Fluted Bowl w/Blossom Jet	1 Submersible Pump, 10 x 14V/6W RGB LED Lights, 1 Blossom 1" Jet	1:55:1
RD08-FA3018NG	8' Dia., Round	30" + 18" Fluted Bowls w/Aerating Jet	1 Submersible Pump, 10 x 14V/6W RGB LED Lights, 1 Aerating 1/2" Jet	1:55:1
RD10-BASIN	10' Dia., Round	Basin Only	1 Submersible Pump, 10 x 14V/6W RGB LED Lights, 1 Jet	N/A
RD10-CJ36NG	10' Dia., Round	36" Column Jet	1 Submersible Pump, 7 x 14V/6W RGB LED Lights, 3 Column Jets	N/A
RD10-SR36NG	10' Dia., Round	36" Spray Ring	1 Submersible Pump, 8 x 14V/6W RGB LED Lights, 40 x Smoothbore 1/8" Jets	N/A
RD10-PA36NG	10' Dia., Round	36" Plaza Bowl w/Aerating Jet	2 Submersible Pumps, 11 x 14V/6W RGB LED Lights, 1 Blossom 1"Jet	1.6:1
RD10-CA36NG	10' Dia., Round	36" Crystal Bowl w/Blossom Jet	2 Submersible Pumps, 11 x 14V/6W RGB LED Lights, 1 Blossom 1" Jet	2.55:1
RD10-CA3624NG	10' Dia., Round	36"+24" Crystal Bowls w/Finial	2 Submersible Pumps, 10 x 14V/6W RGB LED Lights, 1 Finial Bubbler	2.55:1
RD10-CA362418NG	10' Dia., Round	36"+24"+18" Crystal Bowls w/Finial	2 Submersible Pumps, 10 x 14V/6W RGB LED Lights, 1 Finial Bubbler	2.55:1
RD10-FA36NG	10' Dia., Round	36" Fluted Bowl w/Blossom Jet	1 Submersible Pump, 11 x 14V/6W RGB LED Lights, 1 Blossom 1"Jet	1.66:1
RD10-FA3624NG	10' Dia., Round	36" + 24" Fluted Bowls w/Aerating Jet	1 Submersible Pump, 10 x 14V/6W RGB LED Lights, 1 Aerating 1/2" Jet	1.66:1
RD10-FA362418NG	10' Dia., Round	36" + 24" + 18" Fluted Bowls w/Aerating Jet	1 Submersible Pump, 10 x 14V/6W RGB LED Lights, 1 Aerating 1/2" Jet	1.66:1
RD10-FA48NG	10' Dia., Round	48" Fluted Bowl w/Blossom Jet	1 Submersible Pump, 11 x 14V/6W RGB LED Lights, 1 Blossom 1"Jet	1.26:1
RD10-FA4836NG	10' Dia., Round	48" + 36" Fluted Bowls w/Aerating Jet	1 Submersible Pump, 12 x 14V/6W RGB LED Lights, 1 Aerating 1/2" Jet	1.26:1
RD10-FA483624NG	10' Dia., Round	48" + 36" + 24" Fluted Bowls w/Aerating Jet	1 Submersible Pump, 10 x 14V/6W RGB LED Lights, 1 Aerating 1/2" Jet	1.26:1
RD12-BASIN	12' Dia., Round	Basin Only	1 Submersible Pump, 10 x 14V/6W RGB LED Lights, 1 Jet	N/A
RD12-CJ48NG	12' Dia., Round	48" Column Jet	1 Submersible Pump, 7 x 14V/6W RGB LED Lights, 3 Column Jets	N/A
RD12-SR48NG	12' Dia., Round	48" Spray Ring	1 Submersible Pump, 8 x 14V/6W RGB LED Lights, 46 Smoothbore 1/8" Jets	N/A
RD12-PA48NG	12' Dia., Round	48" Plaza Bowl w/Aerating Jet	3 Submersible Pumps, 12 x 14V/6W RGB LED Lights, 1 Blossom 1" Jet	1.21:1
RD12-CA48NG	12' Dia., Round	48" Crystal Bowl w/Blossom Jet	3 Submersible Pumps, 12 x 14V/6W RGB LED Lights, 1 Blossom 1" Jet	2.23:1
RD12-CA4836NG	12' Dia., Round	48"+36" Crystal Bowls w/Finial	3 Submersible Pumps, 10 x 14V/6W RGB LED Lights, 1 Finial Bubbler	2.23:1
RD12-CA483624NG	12' Dia., Round	48"+36" + 24" Crystal Bowls w/Finial	3 Submersible Pumps, 10 x 14V/6W RGB LED Lights, 1 Finial Bubbler	2.23:1
RD12-FA48NG	12' Dia., Round	48" Fluted Bowl	1 Submersible Pump, 12 x 14V/6W RGB LED Lights, 1 Blossom 1" Jet	1.5:1
RD12-FA4836NG	12' Dia., Round	48" + 36" Fluted Bowls w/Aerating Jet	1 Submersible Pump, 10 x 14V/6W RGB LED Lights, 1 Aerating 1/2" Jet	1.5:1
RD12-FA483624NG	12' Dia., Round	48" + 36" + 24" Fluted Bowls w/Aerating Jet	1 Submersible Pump, 10 x 14V/6W RGB LED Lights, 1 Aerating 1/2" Jet	1.5:1





Roxbury Collection - Round & Quatrefoil

All fountains include the following: Timers for pump lights, Individual control valves for each feature, Main drain, Utility drain, Manual fill, Auto water level control, and Chlorinator.

Part. No. Base Size Bowl / Center Feature Additional Information/Elements		Additional Information/Elements	Splash Ratio	
RQ12-BASIN	12' Dia., Quatrefoil	Basin Only	1 Submersible Pump, 10 x 14V/6W RGB LED Lights, 1 Jet	N/A
RQ12-CJ36NG	12' Dia., Quatrefoil	36" Column Jet	1 Submersible Pump, 7 x 14V/6W RGB LED Lights, 3 Column Jets	N/A
RQ12-SR36NG	12' Dia., Quatrefoil	36" Spray Ring	1 Submersible Pump, 8 x 14V/6W RGB LED Lights, 40 Smoothbore 1/8" Jets	N/A
RQ12-PA36NG	12' Dia., Quatrefoil	36" Plaza Bowl w/Frothy Jet	2 Submersible Pumps, 11 x 14V/6W RGB LED Lights, 1 Blossom 1" Jet	N/A
RQ12-CA36NG	12' Dia., Quatrefoil	36" Crystal Bowl w/Tulip Jet	2 Submersible Pumps, 11 x 14V/6W RGB LED Lights, 1 Blossom 1" Jet	N/A
RQ12-CA3624NG	12' Dia., Quatrefoil	36" + 24" Crystal Bowls w/Finial	2 Submersible Pumps, 10 x 14V/6W RGB LED Lights, 1 Finial Bubbler	N/A
RQ12-CA362418NG	12' Dia., Quatrefoil	36" + 24" + 18" Crystal Bowls w/Finial	2 Submersible Pumps, 10 x 14V/6W RGB LED Lights, 1 Finial Bubbler	N/A
RQ12-FA36NG	12' Dia., Quatrefoil	36" Fluted Bowl w/Tulip Jet	1 Submersible Pump, 11 x 14V/6W RGB LED Lights, 1 Blossom 1" Jet	N/A
RQ12-FA3624NG	12' Dia., Quatrefoil	36" + 24" Fluted Bowls w/Tulip Jet	1 Submersible Pump, 10 x 14V/6W RGB LED Lights, 1 Aerating 1/2" Jet	N/A
RQ12-FA362418NG	12' Dia., Quatrefoil	36" + 24" + 18" Fluted Bowls w/Frothy Jet	1 Submersible Pump, 10 x 14V/6W RGB LED Lights, 1 Aerating 1/2" Jet	N/A
RD16-BASIN	16' Dia., Round	Basin Only	1 Submersible Pump, 10 x 14V/6W RGB LED Lights, 1 Jet	N/A
RD16-CJ60NG	16' Dia., Round	60" Column Jets	2 Submersible Pumps, 7 x 14V/6W RGB LED Lights, 3 Column Jets	N/A
RD16-SR60NG	16' Dia., Round	60" Spray Ring	2 Submersible Pumps, 8 x 14V/6W RGB LED Lights, 59 Smoothbore 1/8" Jets	N/A
RD16-PA60NG	16' Dia., Round	60" Plaza Bowl w/Blossom Jet	4 Submersible Pumps, 12 x 14V/6W RGB LED Lights, 1 Blossom 1"Jet	1.71:1
RD16-CA60NG	16' Dia., Round	60" Crystal Bowl w/Blossom Jet	4 Submersible Pumps, 12 x 14V/6W RGB LED Lights, 1 Blossom 1" Jet	2.26:1
RD16-CA6048NG	16' Dia., Round	60" + 48" Crystal Bowls w/Finial	4 Submersible Pumps, 10 x 14V/6W RGB LED Lights, 1 Finial Bubbler	2.26:1
RD16-CA604836NG	16' Dia., Round	60" + 48" + 36" Crystal Bowls w/Finial	4 Submersible Pumps, 10 x 14V/6W RGB LED Lights, 1 Finial Bubbler	2.26:1
RD16-FA60	16' Dia., Round	60" Fluted Bowl w/Blossom Jet	1 Submersible Pump, 12 x 14V/6W RGB LED Lights, 1 Blossom 1" Jet	1.74:1
RD16-FA6048	16' Dia., Round	60" + 48" Fluted Bowls w/Blossom Jet	1 Submersible Pump, 10 x 14V/6W RGB LED Lights, 1 Blossom 1" Jet	1.74:1
RD16-FA604836	16' Dia., Round	60" + 48" + 36" Fluted Bowls w/Blossom Jet	2 Submersible Pumps, 11 x 14V/6W RGB LED Lights, 1 Blossom 1"Jet	1.74:1
RQ16-BASIN	16' Dia., Quatrefoil	Basin Only	1 Submersible Pump, 10 x 14V/6W RGB LED Lights, 1 Jet	N/A
RQ16-CJ48	16' Dia., Quatrefoil	48" Column Jet	1 Submersible Pump, 7 x 14V/6W RGB LED Lights, 3 Column Jets	N/A
RQ16-SR48	16' Dia., Quatrefoil	48" Spray Ring	1 Submersible Pump, 8 x 14V/6W RGB LED Lights, 46 Smoothbore 1/8" Jets	N/A
RQ16-PA48	16' Dia., Quatrefoil	48" Plaza Bowl w/Frothy Jet	3 Submersible Pumps, 12 x 14V/6W RGB LED Lights, 1 Blossom 1" Jet	N/A
RQ16-CA48	16' Dia., Quatrefoil	48" Crystal Bowl w/Tulip Jet	3 Submersible Pumps, 12 x 14V/6W RGB LED Lights, 1 Blossom 1" Jet	N/A
RQ16-CA4836	16' Dia., Quatrefoil	48" + 36" Crystal Bowls w/Finial	3 Submersible Pumps, 10 x 14V/6W RGB LED Lights, 1 Finial Bubbler	N/A
RQ16-CA483624	16' Dia., Quatrefoil	48" + 36" + 24" Crystal Bowls w/Finial	3 Submersible Pumps, 10 x 14V/6W RGB LED Lights, 1 Finial Bubbler	N/A
RQ16-FA48	16' Dia., Quatrefoil	48" Fluted Bowl w/Tulip Jet	1 Submersible Pump, 12 x 14V/6W RGB LED Lights, 1 Blossom 1" Jet	N/A
RQ16-FA4836	16' Dia., Quatrefoil	48" + 36" Fluted Bowls w/Tulip Jet	1 Submersible Pump, 10 x 14V/6W RGB LED Lights, 1 Aerating 1/2" Jet	N/A
RQ16-FA483624	16' Dia., Quatrefoil	48" + 36" + 24" Fluted Bowls w/Frothy Jet	1 Submersible Pump, 11 x 14V/6W RGB LED Lights, 1 Aerating 1/2" Jet	N/A











THE OWNER.

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2. CONTRACTORSHALL OBTAINALL NECESSARY PROVINCIAL ONLESSORY MANUNCIAL ENGINEERS AND CONSTRUCTION SHALL CONFIDENCIAL CO

VISITTHE SITE PRIOR TO CONSTRUCTION TO BECOME FAMILIAR WITH EXIS 1NG CONDITIONS. IF ANY DISCREPANCIES EXIST BETWEENTHE DRAWINGS AND ACTUAL SITECONDITIONS, CONTRACTOR SHALL BRING THIS TO THE ATTENTION OF THE LANDSCAPE ARCHITECT.

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4. EXIS "ING UNDERGROUNDUTILITIES SHOWN ON THE DRAWINGS ARE PLOTTED FROM ORIGIN ALSITE DRAWINGS AND/OR SITETOPOGRAPHIC SURVEY, EVERY ATTEMPTHAS BEENMADE TO SHOW ALLUTILITY LINES. SURVEY, UPER ATTEMPTHAS SEENANDE TO SHOW ALL UTILITY LIVES WHERE THEY BOST CONTRACTION SHALL USE VERY PREACTION IN BECAMA INGSINGE ACTUAL UNDERFROUND UTILITIES WANTON TE AS SOWN CONTRACTOR SHALL WISE WISE THROUGHOUTH FRILLIAN SHALL WAS HERE THROUGHOUTH FRILLIAN SHALL WAS HERE THROUGHOUTH FRILLIAN SHALL WAS AND SHALL WISE THROUGH SHALL WISE THROUGH SHALL WISE THROUGH SHALL WISE THROUGH SHALL WOUTH SAUTH SHALL WAS SHALL WISE TO SHALL WISE THROUGH SHALL WAS THR

CONSTRUCTION FROM DAMAGE. SHOULD ANY DAMAGE OCCUR. CONTRACTOR SHALL MAKE ALL NECESSARY REPAIRSAT NO COSTTO.

7. CONTRACTOR SHALL COORDIN ATE HIS WORK WITH OTHER

TO PAYMENT APPROVAL.

12. CONTRACTOR SHALL PROVIDE MARKED-UPREDLINE PLANS
SHOWING AS-BUILT SITE CONDITIONS TO THE LANDSCAPE.ARCHITECT, PRIOR TO OBTAINING APPROVALOF SUBSTANTIAL COMPLETION.

13. AT ALLEDGES OF EXIS I NGSIDEWALK ORCUR BAGAINSTWHICH
NEW CONCRETE ISTO BE PLACED. SAWCUT AND REMOVE EXISTING. CONCRETE BACKTO THE NEAREST CONTRACTION JOINTTO PROVIDE A SMOOTH TRANSTION TO THE NEW CONCRETE.

14. INSTALL ISOLATION JOINTS AT A LLOCATIONS WHERENEW CONCRETE MEETS EXISTING CONCRETE PAVEMENT.

LANDSCAPE NOTES

1. ALL PLANTING AND INSTALLATION IN RIGHT OF WAY SHALL MEET LOCAL MUNICIP ALST AND ARDS AND SPECIFIC A "IONS 2. LANDSCAPE CONTRACTOR SHALL COORDINATE HIS WORK WITH OTHER CONTRACTORS ON SITE TO MINIMIZE DAMAGE TO COMPLETED LAWN AND PLANT MATERIAL INSTALLATION.

LAWN AND PLANT MATERIALINSTALLATION.

3. IF ANY DISCREP ANCY EXISTS BETWEEN THE QUANTITIES. SIZES OR. MATERIALS INDICATEDON THE PLAN AND SHOWN IN THE PLANT LIST,

MATERIA'S INDICATEON THE RIAM AND SHOWN IN THE PLANT LIST, THE RIAM SHALL GOVERN I. ALL STATEMENT AND SHALL GOVERN I. ALL STATEMENT AND SHALL SH

CONSTRUCTION.

8. PRIOR TO SPREADING TOPSOIL, LANDSCAPE CONTRACTOR SHALL.

INSPECT AND ACCEPT ALL BASE GRADES, ANY DEVIATION FROM LINE AND GRADE INDICATED ON THE GRADING PLAN SHALL BE CORRECTED. BY EARTHWORK CONTRACTOR BEFORE PLACING ANY TOPSOIL BEFORE PLANT MATERIAL INSTALLATION BEGINS, STAKE LOCATIONS
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11. ALL GRADING, UTILITY, AND IRRIGATION WORK SHALL BE COMPLETED PRIOR TO INSTALLA () ON OF PLANT MATERIAL AND LANDSCAPE MULCH. 12. ALL PLANT MATERIAL SHALL BEGROWN IN CLAY SOIL. ALL SHRU BS SHALL BE GROWN IN FIBRE POT CONTAINERS. ALL TREES SHALL BE NURSERY GROWN AND TRANSPLANTED USINGTHE BALL AND BURL AP METHOD

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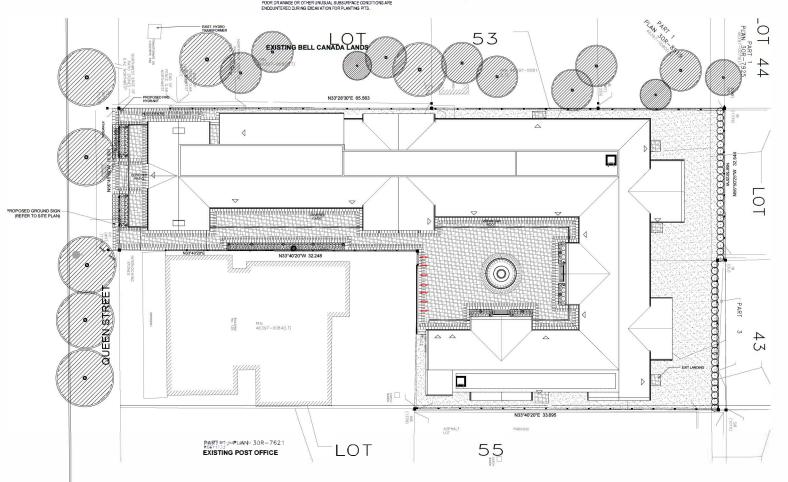
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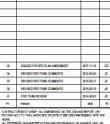
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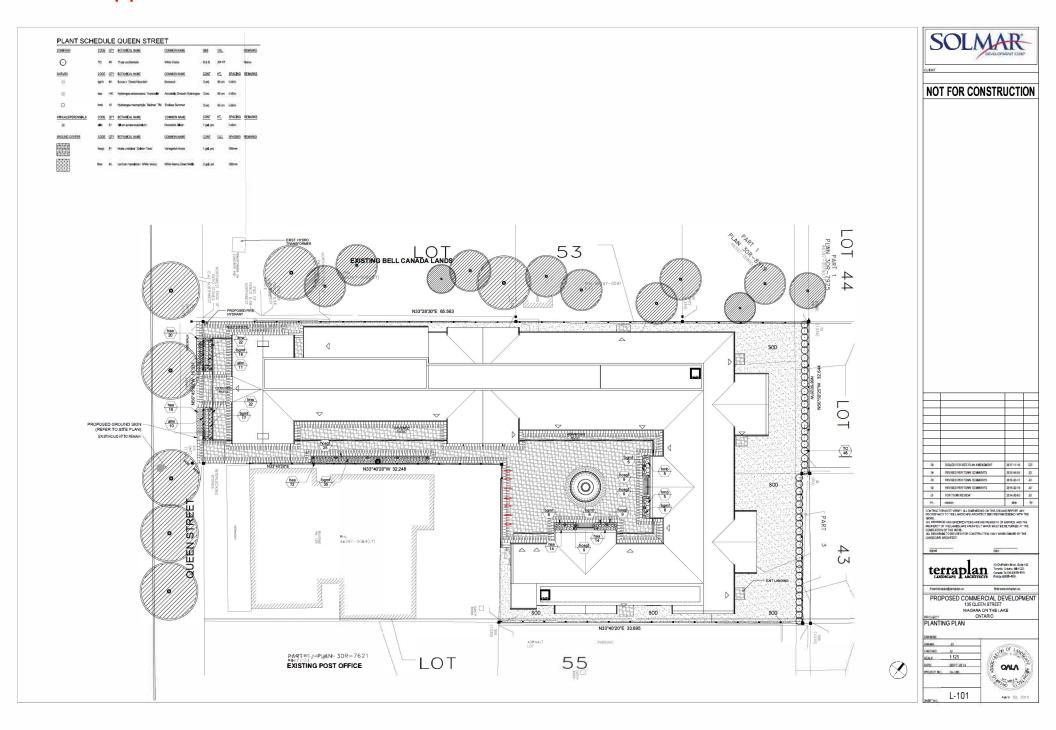
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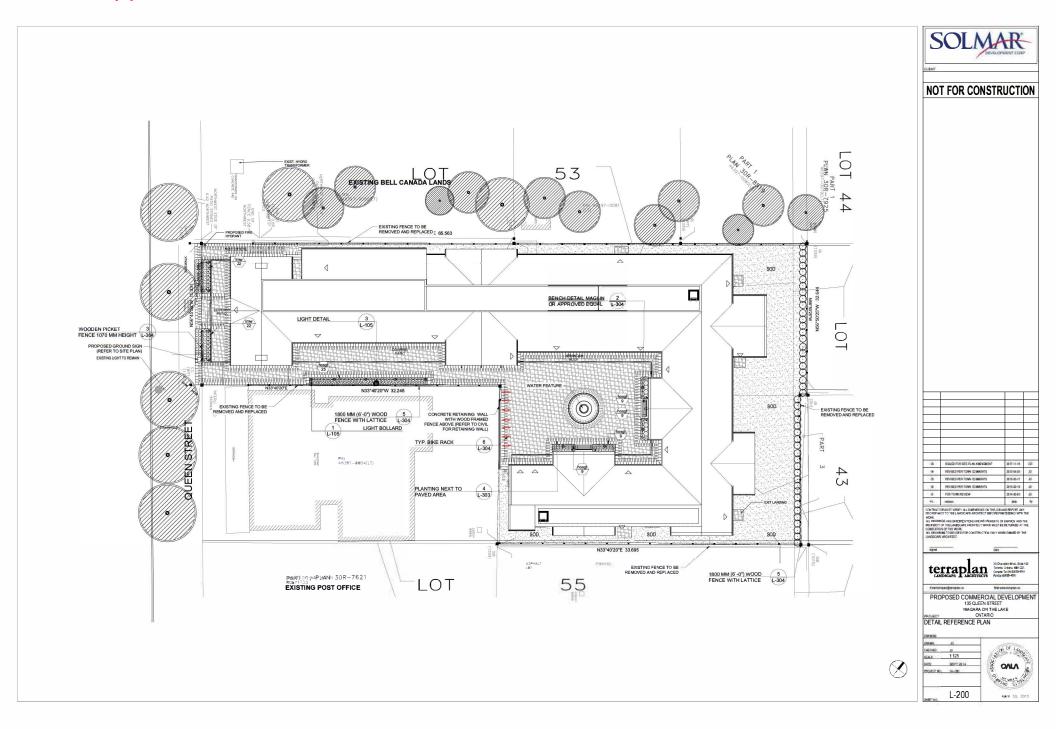
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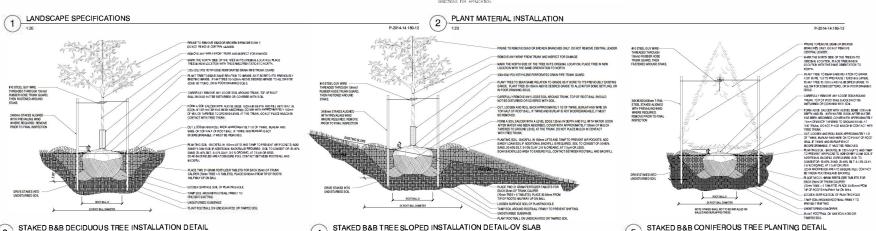
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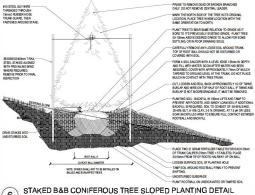
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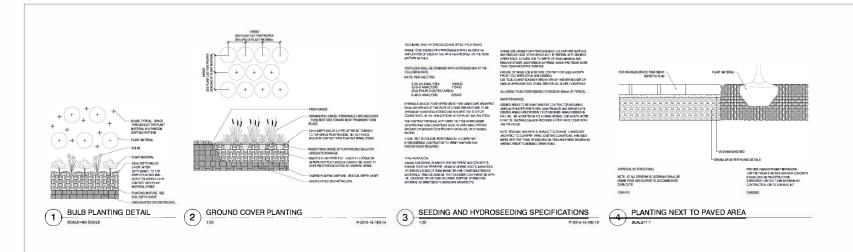
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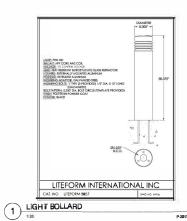
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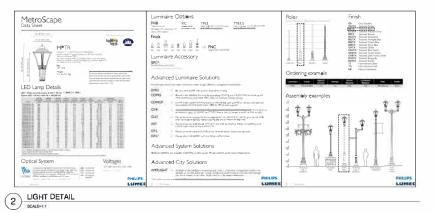
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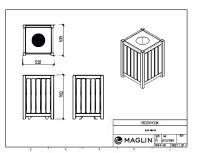
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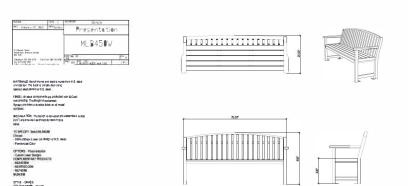
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1593 Four Mike Creek Road P.O. Box 190 Virgil, Ontario L0S 1T0

Telephone (905) 468-3266 Facsimile (905) 468-2959

MHC-18-029

Committee Date:

June 12, 2018

Report To:

Committees of Council

Subject:

Report:

135 Queen Street - Heritage Permit Application - New Building

1. RECOMMENDATION

It is respectfully recommended that:

- 1.1 the heritage permit application for 135 Queen Street to permit revisions to the approved Site Plan, Landscape Plan and Building Elevations for the subject property, be approved, in accordance with the drawings attached as **Appendix A**, subject to the following conditions:
 - a) the door at the west building elevation of 135 Queen Street be removed, to the satisfaction of the Director of Community and Development Services;
 - b) the final capping system design be approved to the satisfaction of the Municipal Heritage Committee;
 - c) the applicant return to the Municipal Heritage Committee for final approval of the water fountain designs; and
 - d) the applicant provide for additional trees on the landscaping plan internal to the site, to the satisfaction of the Municipal Heritage Committee.

2. PURPOSE / PROPOSAL

The purpose of this report is to review the Heritage Permit Application to permit revisions to the approved site plan for the subject property. The application proposes the construction of a new structure of with a ground floor area of 840 m².

The application, including a Site Plan, Landscape Plan and Building Elevations, are attached as **Appendix A**.

3. BACKGROUND

3.1 Site Description

The property is a deep L-shaped lot on the North side of Queen Street which

formerly had a Gothic house at the street and large barn in the rear. The barn has since been demolished. The house was one-and-a-half storey with Gothic revival profile, which reputedly dated to ca 1835 but of somewhat later appearance. John Burns operated a shoe-making and leather goods business on the premises at that time. Modern bay windows flanked an entrance with sidelights and reeded pilasters, and a rather large flat-headed window was located in the gable peak. The timber frame structure of the Gothic house was dismantled in 2015 and is currently in storage to be reconstructed with the new development.

3.2 Relevant Past Property Alterations and Information

A Site Plan, Landscape Plan and Building Elevations, attached as **Appendix B** to this report were approved by Town Council in April 2015, based on recommendations of the March 2015 Municipal Heritage Committee. The applicant has advised that the project is currently undergoing a Site Plan Amendment due to a Stage 4 Archaeological Assessment necessitating the 'capping' of the approved structure, by placing a minimum number of concrete pillars at select locations that would support a platform, on which the structure can be supported. Correspondence from the Ministry of Tourism, Culture and Sport has been received, included in **Appendix C**, indicating that the proposed construction method is likely to reduce impacts by placing the minimum number of concrete pillars at select locations that will support a platform on which the structure can be supported over the archaeological site.

4. DISCUSSION / ANALYSIS

4.1 Ontario Heritage Act

The property is in the commercial area of the Queen-Picton Heritage Conservation District and is designated under Part V of the Ontario Heritage Act. Section 42 of the Ontario Heritage Act states as follows:

Erection, demolition, etc.

- 42. (1) No owner of property situated in a heritage conservation district that has been designated by a municipality under this Part shall do any of the following, unless the owner obtains a permit from the municipality to do so:
- 1. Alter, or permit the alteration of, any part of the property, other than the interior of any structure or building on the property.
- 2. Erect, demolish or remove any building or structure on the property or permit the erection, demolition or removal of such a building or structure. 2005, c. 6, s. 32 (1).

4.2 Queen-Picton Heritage Conservation District (District Plan)

The following Physical Goals are included in the District Plan:

- to achieve a cohesive, well-designed district that emphasizes the human scale and historic character of the streetscape:
- to guide the construction of new buildings so that they are of good design, compatible with the historic district

The former building was considered a 'B' building. The new building however, will be assessed as a "New Building" as per the "Section 5A.3 - New Building" of the District Plan which states:

New building is encouraged on existing vacant sites or where buildings have been destroyed or demolished. New buildings should be looked upon as an opportunity to embellish the streetscape composition. It is not the intent or desire that new building should reproduce past building styles but rather that it should be of good compatible design and complementary to the height, proportion, scale and character of the district. In this regard the following criteria should be adhered to:

Height - the height of new buildings at the street face shall be sympathetic to surrounding buildings. Single storey buildings will not be permitted where they weaken the continuity of the visual streetscape composition.

Proportion - proportions of alterations, or new buildings shall complement the proportions of the surrounding buildings.

Roof - the roof pattern shall be similar to the established roof patterns of the "A" and "B" building stock.

Windows - the placement and proportion of height to width of windows shall complement those of surrounding buildings.

Colours - colours used through paint and materials shall be historically accurate colours, being of quiet, subtle, natural shades.

Materials - materials appropriate and typical of the heritage district shall be used with an emphasis on natural fabric such as brick, stone and wood as opposed to metals and plastics.

Set Back - set back of new building shall be similar to that of the existing building so as to maintain an integrity of building edge. Where the existing set back is exceptionally deep a maximum 20 feet set back will prevail.

Store Fronts - new store fronts shall be complementary to the scale and proportions of the street facades. A liberal design approach is encouraged to foster individuality of the type of business and the proprietor's taste

<u>Section 6A.3.3 - Treescape - Policies</u>

The following policies related to the treescape are contained within the District Plan:

- Treescape in the business district should be recognized as a significant and contributing feature to the attractiveness of the district.
- Treescape in the business district should be maintained, enhanced and

expanded in a manner to complement the goals of the plan.

- Treescape planting design should be simple, effective and robust .

4.3 Review of Proposal

A request for comments had been considered by the Municipal Heritage Committee at the October 10, 2017 Committee meeting. Drawings were presented to the Committee, including a proposed Site Plan and Building Elevations. The Staff report requested revisions to the drawings as follows:

- 1. The roofline at the farthest right on south elevation drawing AD1.1 is saltbox style. It is recommended that if a saltbox roof is necessary on this elevation that there be no eaves returns.
- 2. Note on south elevation drawing AD1.3 that the siding material will be wood clapboard and note the proposed exposure.
- 3. As per earlier Heritage Committee recommendation's the porch roof should not be as deep as depicted on the revised drawings.
- 4. Recommend that the building be narrowed in some sections to create an almost breezeway-like connection spaces which would give the illusion of separate buildings and could assist in reducing the linear massing.
- 5. Revised Landscape Plan drawings will be required for any changes to the original designs.

Requested revisions 1 through 3 have been incorporated into the proposed Site Plan. Regarding request 4 the applicant provides that the proposed building needed to be merged into one building in order to address the servicing of the site. Specifically, if separate buildings were proposed, the digging of trenches would be required in order to provide services for restroom facilities, which would result in disturbances to the site. The Municipal Heritage Committee provided additional comments at the meeting suggesting that the proposed building was overpowering, and suggesting options be considered to break-up the existing building, such as the use of a "Utilidor" system. There have been minor amendments to the west elevation; including indents at portions of the building to provide for the appearance of breaks in the massing of the building.

Staff note that the proposed building would provide for 60% lot coverage on the site, and is substantively larger than the original approved building. While the proposed building's footprint would be significantly larger than the originally approved building, Staff note that the focus of the District Plan is on the streetscape and on emphasising human-scale development in the District. The increase in lot coverage would primarily be noticed from internal to the site and in the top down plan view, and would likely have minimal impact on the overall streetscape. Furthermore, the height of the building remains sympathetic to surrounding buildings in the District. For these reasons, Staff are of the opinion that the proposed Site Plan and Building Elevations meet the intent of the District Plan.

There are minor revisions that would be required in order to comply with the Town Zoning By-law, including the removal of a door at the west building elevation.

Capping of the archaeological site may have an adverse impact on the character of the streetscape. Specifically, the capping may raise the apparent elevation and height of the proposed building, as viewed from the street and adjacent buildings. As such, Staff are requesting that additional information be provided including design details of the proposed capping system.

These items are included in the recommendations.

4.4 Landscape Plan

A Landscape Plan has been prepared, which includes the provision of interlocking pavers and a fountain in the middle of the site. A cedar hedge is proposed at the rear of the site to mitigate impacts on the abutting rear residential use. Planting beds are included throughout the site consisting of ground-covers, shrubs and perennials. In general, the proposed landscaping appears to provide for a functional and useable amenity space for the commercial property.

Staff note that there are a lack of trees planted internal to the site. Section 6A.3.3 of the District Plan encourages tree planing within the business area of the District. While the overall landscaping plan is well-designed, it is recommended that the applicant explore options to incorporate the planting of trees internal to the site, without adversely impacting the archaeological resources on the property. Details of the water feature have not been provided at this time, and it is requested that the water feature receive final approval by the Municipal Heritage Committee.

5. STRATEGIC PLAN

Not applicable.

6. OPTIONS

Not applicable.

7. FINANCIAL IMPLICATIONS

No costs will be incurred by the Town as a result of approval of this application. If approved, the applicant is responsible for all fees related to this application including building permits fees and site plan application fees.

8. COMMUNICATIONS

The recommendations of the Municipal Heritage Committee will go to Council for final approval. Sections 33 and 42 of the Ontario Heritage Act set out that, within 90 days after the notice of receipt is served on the applicant, the council may give the applicant:

- (a) the permit applied for;
- (b) notice that the council is refusing the application for the permit; or
- (c) the permit applied for, with terms and conditions attached.

The <u>Ontario Heritage Act</u> should be consulted in regards to process and for further information. No alterations can take place on the property until Council approval and a Heritage Permit has been received by the applicant. It is the applicant's responsibility to ensure that all necessary planning and building approvals and permits have been obtained.

9. CONCLUSION

Staff recommend approval of the Heritage Permit application for 135 Queen Street, subject to the conditions noted in Section 1 of this report, as the proposal is considered to be consistent with the intent of the Queen-Picton Heritage Conservation District Plan.

Respectfully submitted,

Jesse Auspitz, MCIP, RPP

Planner II

Eric Withers, MCIP, RPP Manager of Planning (A)

ATTACHMENTS

PDF

PDF

PDF

Appendix A.pdf Appendix B.pdf Appendix C.pdf

First Capital of Upper Canada - 1792

Report: MHC-18-029





HAND DELIVERED

December 21, 2017

Town of Niagara-on-the-Lake Planning and Development Services 1593 Four Mile Creek Road P.O. Box 100 Virgil, Ontario LOS 1T0

Attention: Ms. Denise Horne, M.A., Dip. Heritage Conservation, Planner I

Dear Madam,

RE: Heritage Permit Application

135 Queen Street

Town of Niagara-on-the-Lake, Region of Niagara

Our office is pleased to enclose a Heritage Permit Application for lands municipally addressed as 135 Queen Street ("Subject Lands").

Background

Equity Venture Group Corp. is the registered Owner of lands legally described as Part of Lots 42, 43, 54 and 55 Registered Plan TP-86 and municipally addressed as 135 Queen Street.

The Subject Lands are currently vacant and deemed a significant archeological site, requiring a Stage 4 Archeological Assessment, which has been discussed with the Ministry of Culture and Sport including the Town.

The Owner is proposing a Site Plan Amendment concurrent with the enclosed Heritage Permit application, necessary to permit the approved commercial development on the Subject Lands with the inclusion of a 'capping' of the archeological site; an approach deemed satisfactory to the Ministry.

Site Plan Amendment

As mentioned, the Owner is proposing to amend the approved Site Plan in order to facilitate a 'capping' of the archeological site, for the purpose of limiting ground disturbances.

The proposed commercial development maintains its original intent of use being a Restaurant, Office and Retail uses together with the condition of adaptive reuse of the disassembled heritage structure which is currently in storage.



EQUITY VENTURE GROUP CORP.

The Site Plan Amendment proposes to merge the previously approved three structures into one, while maintaining the 'L-Shape' articulation of the previously approved Site Plan.

The Site Plan Amendment further proposes the following changes, as per the requirements of the Municipal Heritage Committee and in support of a Heritage Permit:

- 1. the roofline at the farthest right on the south elevation is now without an eave returns (e.g. salt box roof).
- 2. the siding material is noted as wood clapboard;
- 3. reduction of the front patio/porch to ensure the same does not detract from the actual building (e.g. Restaurant);
- 4. the building was narrowed in sections to create breezeway-like connections and to reduce the massing of the building, and

The proposed structures will be constructed in part using a 'Structural Platform' instead of conventional foundations, in order to meet the requirements of the Ministry, as they would pertain to the 'capping' approach deemed acceptable". The remaining structure (rear section) will be constructed using conventional foundations once the Ministry clears the Stage 4 Archeological Assessment.

From a Site Servicing perspective, the Site Plan Amendment proposes to introduce water, sanitary and storm services through adjacent lands owned by the Owner, municipally addressed as 178 Gate Street, in order to avoid disturbances to the archeological site.

The adjacent lands will not form part of the proposed Site Plan but rather an Easement will be conveyed to the Town in order to ensure access and maintenance for the municipal services.

The adjacent lands will be restored to their original state and the services will not be visible.

The Owner has pre-consulted on the proposed Site Plan Amendment with Town Planning and Operations Staff including a formal update before the Municipal Heritage Committee on October 10th, 2017.

The enclosed amended Plans reflect the recommendations of the Heritage Committee and maintain conformity to the site specific zoning by-law while maintaining the essence of the approved Site Plan.

Submission Requirements

In support of the requested Heritage Permit application, please find enclosed the following Submission Items:

- > One (1) copy of a completed Heritage Permit application form, as prepared by the undersigned (Please note, building materials and colours are listed on the enclosed architectural plans)
- > One (1) copy of a proposed Site Plan Amendment Drawing(s), Nestico Architect Inc.;



EQUITY VENTURE GROUP CORP.

> One (1) copy of a revised Landscape Plan, Planting Plan and Landscape Details, as prepared by Terraplan Landscape Architects;

Please proceed to schedule our attendance before the Municipal Heritage Committee.

Your ongoing attention and assistance regarding this matter is greatly appreciated.

Should you have any questions or require further information, please do not hesitate to contact the undersigned.

Yours truly, EQUITY VENTURE GROUP CORP.

Maurikio Rogato, B.U.R.Pl., M.C.I.P., R.P.P. Land Development

Mr. Sam Nestico, Nestico Architect (Letter Only) Mr. David Jonas, Terraplan Landscape Architects (Letter Only) Mr. Jason Schooley, Upper Canada Planning & Engineering Ltd.





Department of Community & Development Services 1593 Four Mile Creek Road P.O. Box 100, Virgil, ON LOS 1T0 905-468-3266 • Fax: 905-468-0301

- www.notl.org -

Niagara-on-the-Lake Heritage Permit Application

Policies for Processing Applications for Heritage Permits

The requirements to complete a Heritage Permit application are to submit:

- 1. One fully completed application form for a Heritage Permit signed by the property owner(s) to the satisfaction of the Town.
- 2. All required supporting information or material after consultation with the Heritage Advisor to the satisfaction of the Town (checklists are attached).

Heritage Permit applications are to be filed with the Town of Niagara-on-the-Lake Community and Development Services Department both in print and digital copy. Applications will not be processed until they are complete after which a Notice of Receipt shall be served on the applicant by the Community and Development Services Department.

A representative must be present at the Municipal Heritage Committee meeting at which the application is considered.

It is the policy of the Town of Niagara-on-the-Lake Community and Development Services that all applicants must consult with the Heritage Advisor <u>prior</u> to submitting an application.

For further information and to arrange for a pre-consultation meeting, please contact Denise Horne at 905-468-3266 ext. 297 or dhorne@notl.org. Alternatively, you can contact the Community and Development Services Department and ask to speak with a planner.





Department of Community & Development Services 1593 Four Mile Creek Road P.O. Box 100, Virgil, ON LOS 1T0 905-468-3266 ◆ Fax: 905-468-0301

www.notl.org —

APPLICATION FOR HERITAGE PERMIT

A. APPLICANT INF	ORMATION		10.0357			
Applicant Name	Equity Venture Group	equity Venture Group Corp.				
Mailing Address	122 Romina Drive, Co	oncord, ON, L4K	4Z7			
Phone Number	905-660-9222 EXT. 2	30				
E-mail ***	mrogato@solmar.ca					
Is the applicant the ov	vner of the property?	✓Yes	No			
B. PROPERTY OW	NER INFORMATION	Contraction of the last				
Property Owner Name	Equity Venture Group	Corp.				
Mailing Address	122 Romina Drive, Co	oncord, ON, L4K	4 Z 7			
Phone Number	905-660-9222 EXT. 2	30				
E-mail ***	mrogato@solmar.ca					
*** By providing an e-m from the Town and the	Municipal Heritage C	ommittee by ema		ons and notices		
	ERTY & PROPOSEI	D PROJECT		IN Section 1889 (Section 1881)		
Application is made			ī	7		
Construct	Alter	Demolish		Erect a Sign		
Subject Property Address	135 Queen Street					
Explain all work to be undertaken as part of this project (for detailed projects and any project with an associated building permit or planning application attach extra pages as necessary)	consisting of a restaurant and retail uses within one structure. The Project has been Site Plan Approved and a Heritage Permit was issued previously which requires the reintroduction of a					

Explain: Reasons for proposed alter	ations	Due to the subject lands being an Archeological Site, the approved development must be amended to introduce 'capping' of the site and merging of the approved structure into one building to avoid site disruption in accordance with the Ministry of Culture and Sport Guidelines.					
Explain: How the proportion enhances the cheritage attributed the property armeets the policities the Heritage Conservation I Plan	cultural ites of id/or cies of	The Proposal has been previously approved by the Town's Heritage Committee and Town Council. The amended Site Plat continues to contain the design recommendations of the previously approved Site Plan with exception of the merging of the structure into one building but all setbacks have been maintained and the front patio has been reduced in mass.					
Are any other or projects being considered in the near future? If please explain	ng he so,	None.					
Other necessar ✓ Building Per		vals include: Site Plan	Sign Permit	Other			
For (specify w Site Plan Amer development. D. MATERIA	ndment		nit for construction of the	e approved commercial			
Attribute to be impacted	Exist	ing Material	Proposed Material	Proposed Colours			
Exterior Treatment	Vacant Site		See Site Plan Drawings: 1. Lap Siding 2. Trim Boards 3. Fascia and Sofit 4. Crown Mouldings 5. Window & Door Frames	See Colour Schedule			
Roof	Vacant Site		Metal Roof	Charcoal(QC306)			



Trim			
Doors		¥-	
Windows			
Porch/ Verandah			
Fencing			
Landscaping		÷	
Interior Features	**		
Other			

The following information must be submitted with every Heritage Permit Application:
Recent photos of all elevations to be impacted (current condition within last 2 months)
Site Plan of property and buildings
Perspective Drawings
Building Elevations
Proposed colours & materials (where there is a change or repair)
Specifications for type and application of materials (where there is a change or repair)
Historic photos of property (where available)
Information which may be required in consultation with staff depending on the project includes:
Heritage Impact Assessment
Streetscape Study
✓ Landscape Plan
Floor Plans
Other: Heritage Impact Assessment previously filed and approved.
I/We the Owner(s)/Agent of the subject property, and the applicant(s) of this subject application, by signing this application agree to allow either staff and/or a Committee Member of the Town of Niagara-on-the-Lake Municipal Heritage Committee the right to enter onto my property, as necessary, to view & photograph the property for the proposal. Failure to allow access onto the property may result in the application being considered incomplete.
The applicant acknowledges that the Municipality considers the application forms and all supporting materials including studies and drawings, filed with any application to be public information and to form part of the public record. With the filing of an application, the applicant consents and hereby confirms that the consent of the authors of all supporting reports have been obtained, to permit the Municipality and Region to release the application and any supporting materials either for its own use in processing the application, or at the request of a third party, without further notification to, or permission from, the applicant. Date: Dec. 19, 2017 Print Name: Maurizio Rogato
OWNER Signature:
**Email Heritage Permit to: mr@gato@solmar.ca
** By providing an e-mail address you agree to receive communications and notices from the Town and the Municipal Heritage Committee by email

NIAGARA ON THE SECTION 7.7 - QUEEN PIC	ZONING BY-LAW 4316-09	BY-LAW		
GENERAL EMPLOYMENT (GE) ZONE	REQUIREMENTS	PROPOSED	BY-LAW REFERENCE	COMPLIANCE
LOT AREA		1584.41m2	N/A	YES
LOT FRONTAGE	15.33m	15.33m	Section 7.14.62.1.(a)	YES
LOT COVERAGE, INCLUDING COVERED PATIO'S + AREAS - ZBL ITEM	60% (MAX)	TOTAL = 950.6m2/1584.41m2 =	Section 7.14.62.1.(e)	YES
FRONT YARD SETBACK	0m	0.937m	Section 7.7.4	YES
NTERIOR SIDE YARD SETBACK	0m	0.915m (WEST), 1.221m (EAST)	Section 7.7.4	YES
EXTERIOR SIDE YARD SETBACK	N/A	N/A	N/A	N/A
REAR YARD SETBACK (AS PER FIG 7.14.62:135 QUEEN ST)	STAGGERED WITH MINIMUM DIM = 4.57m	5.21m	Section 7.14.62.1.(c)	YES
BUILDING	7.39m		Section 7.14.62.1.(d)	YES
MIN. LOT DEPTH	33.69m	65.563m	Section 7.14.62.1.(b)	YES
LANDSCAPE AREA - ZBL ITEM M	N/A	633.81m2	Section 6.25	YES
BUFFER STRIP ABUTTING A RESIDENTIAL	1.524m W/CONTINUOUS NATURAL LIVING FENCE AND BE IN ACCORDANCE WITH SECTION 6.6	1.524m W/CONTINUOUS NATURAL LIVING FENCE AND BE IN ACCORDANCE WITH SECTION 6.6	Section	YES
PROPOSED GROSS FLOOR AREA (MEASURED FROM INTERIOR FACES OF THE EXTERIOR WALLS) ZBL ITEM F	BE IN AGGRESANCE WITH GEGNON 6.5	1147.53m2	Section 5	
PARKING REQUIREMENTS (BASED ON THE GROSS LEASABLE FLOOR AREA)				YES
GROUND FLOOR (RESTAURANT + RETAIL/ OFFICE - ZBL ITEM I)				
GROUND FLOOR (PATIO AREAS + COVERED AREAS - ZBL ITEM L)				
TOTAL PARKING SPACES REQUIRED	18 CARS	CASH IN LIEU AGREEMENT		
DRIVEWAYS + AISLES WIDTH	N/A	N/A	N/A	YES
MIN. HC PARKING SPACES 3.7m (W) X 6.0m (L)		CASH IN LIEU AGREEMENT		YES
MIN. PASSENGER BUS PARKING	N/A	N/A	Section 6.43(a)	N/A
MIN. LOADING SPACES (3.6 X 9.0m)	N/A	N/A	Section 6.27.(h) Table 6-2	YES
OUTDOOR PATIO RESTAURANT - ZBL ITEM	MAX 50% OF RESTAURANT GFA (MAX 90m2 IN	PATIO 'A' + 'B' = 25.84m2 + 41.01m2 =	Section 6.36.(a)	YES
BICYCLE PARKING (BASED ON THE GROSS LEASABLE FLOOR AREA) RESTAURANT USE - ZBL ITEMS G+J COMMERCIAL USE - ZBL ITEMS H+K	2 PER 100m2 RESTAURANT USE (439.95) = 8.8 BIKES 2 PER 200m2 COMMERCIAL USE (365.7) = 3.65	13 BIKES	Section 6.41 - Table 6-7	YES

ZONING BY-LAW MATRIX.

N.T.S

PROPOSED GROSS FLOOR AREA (MEASURED FROM INTERIOR FACES OF THE EXTERIOR WALLS) = C + D + E = 11,146.83 SF (1035.63m2)PROPOSED UNIT 1 (RESTAURANT USE) GROUND FLOOR GROSS LEASABLE FLOOR AREA (MEASURED FROM EXTERIOR FACE OF OUTSIDE WALLS) EXCLUDING HC WASHROOM + EXIT STAIRS = 4016.01 SF PROPOSED UNITS 2 TO 5 (OFFICE/RETAIL USES) GROUND FLOOR GROSS LEASABLE FLOOR AREA (MEASURED FROM EXTERIOR FACE OF OUTSIDE WALLS) EXCLUDING M/E + SPK + HC WASHROOMS + GARBAGE RM = 3468.34 SF (322.22m2) PROPOSED UNITS 1 TO 5 (RESTAURANT/OFFICE/RETAIL USES) GROUND FLOOR GROSS LEASABLE FLOOR AREA (MEASURED FROM EXTERIOR FACE OF OUTSIDE WALLS) WITH NOTED EXCLUSIONS = G + H = 7484.36 SF (695.32m2) PROPOSED RESTAURANT USE COVERED PATIO AREAS A + B = 719.56 SF (66.85m2) PROPOSED COVERED AREAS = C TO E = 468.01 SF (43.48m2) PROPOSED TOTAL COVERED PATIOS + COVERED AREAS = J + K = 1187.58 SF (110.33m2) LANDSCAPE AREA = 6822.27 SF (633.81m2) 40.01% OF LOT AREA PROPOSED GROUND FLOOR AREA (MEASURED FROM EXTERIOR FACE OF OUTSIDE WALLS)= 9044.60 SF (840.27m2) AKA BUILDING AREA IN O.B.C MATRIX. LOT COVERAGE (60% PERMITTED) = (L+N) / A = 950.6m2/1584.41m2 = 59.99%. PROJECT STATISTICS

PROJECT STATISTICS

LOT AREA = 17,054.45 SF (1584.41m2) EXISTING BUILDINGS = 4131 SF (384m2)

1045.61 SF (97.14m2)

N.T.S





135 QUEEN STREET

Niagara-on-the-Lake, ON L0S 1J0

RE-ISSUED FOR 'SPA AMENDMENT APPLICATION'


ZONING MATRIX & PROJECT STATISTICS


Vaughan, ON. L4K 4R7	DATE	SCALE	REVISION NO.	JOB NO.	DRAWING NO.
905.669.7000 NesticoArchitect.on.ca VaughanArchitect.ca	2017.12.08	N.T.S	R4	15624	AD0.0

PROPOSED GROUND FLOOR AREA (MEASURED FROM INTERIOR FACES OF THE EXTERIOR WALLS) = 8138

PROPOSED 2ND FLOOR AREA (MEASURED FROM INTERIOR FACES OF THE EXTERIOR WALLS) = 1963.22 SF

PROPOSED BASEMENT FLOOR AREA (MEASURED FROM INTERIOR FACES OF THE EXTERIOR WALLS) =

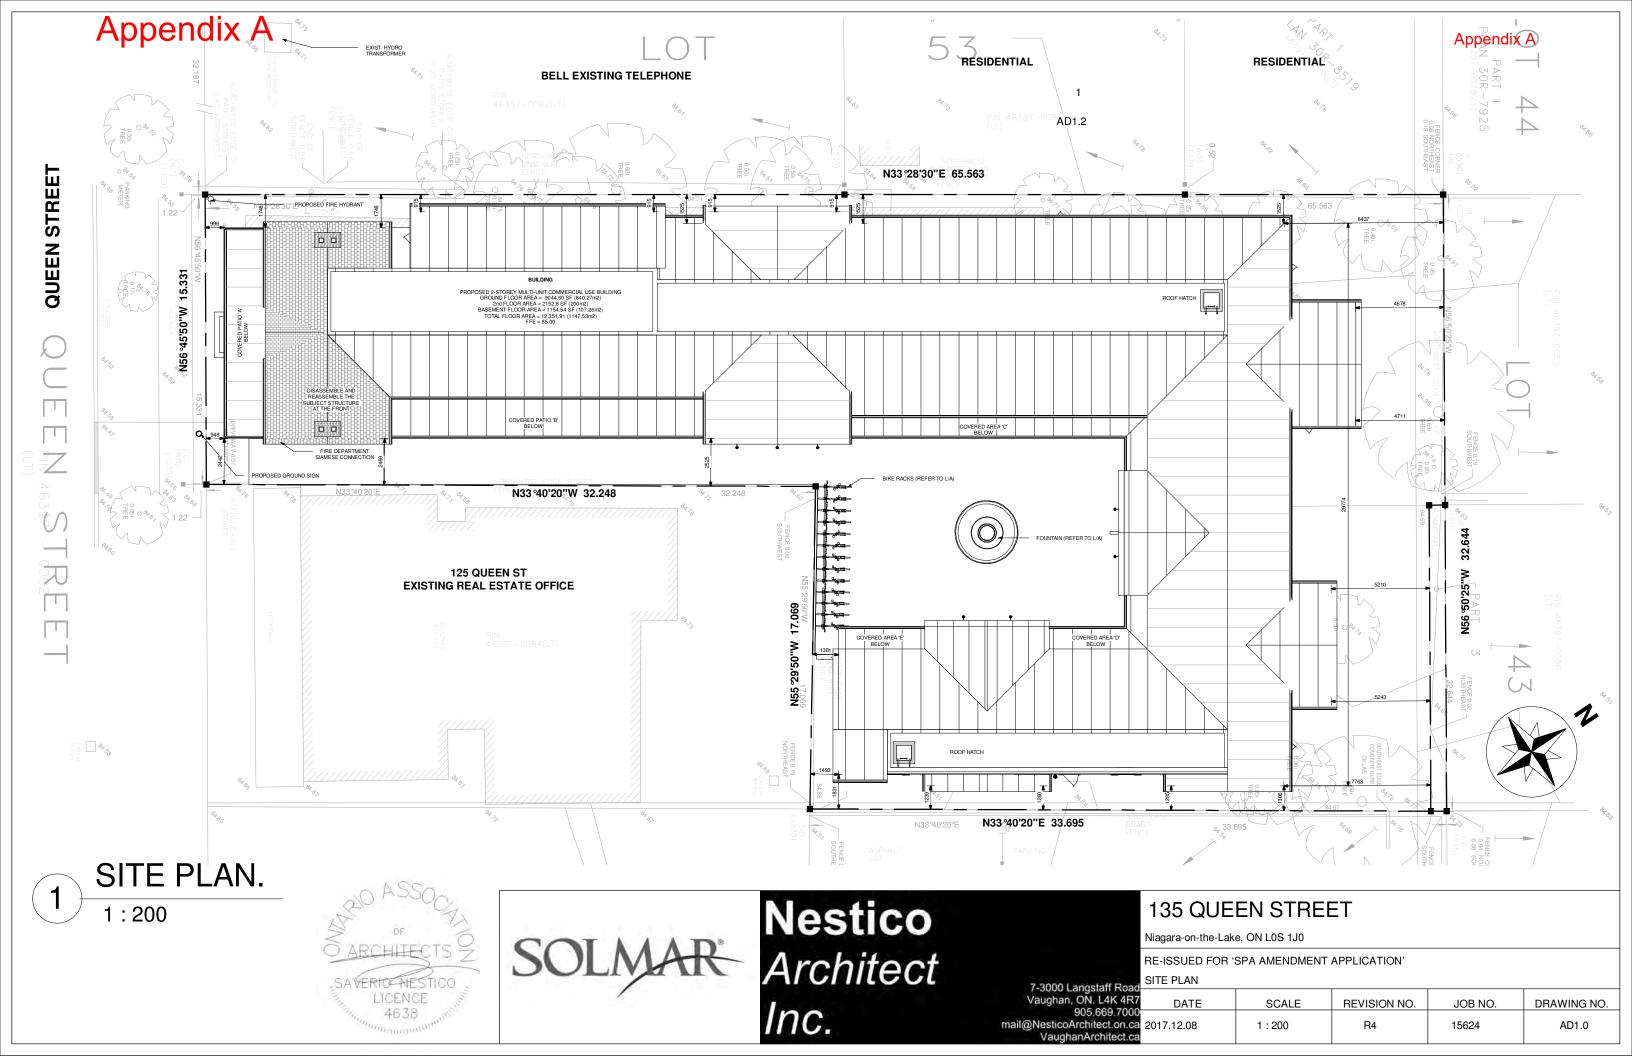

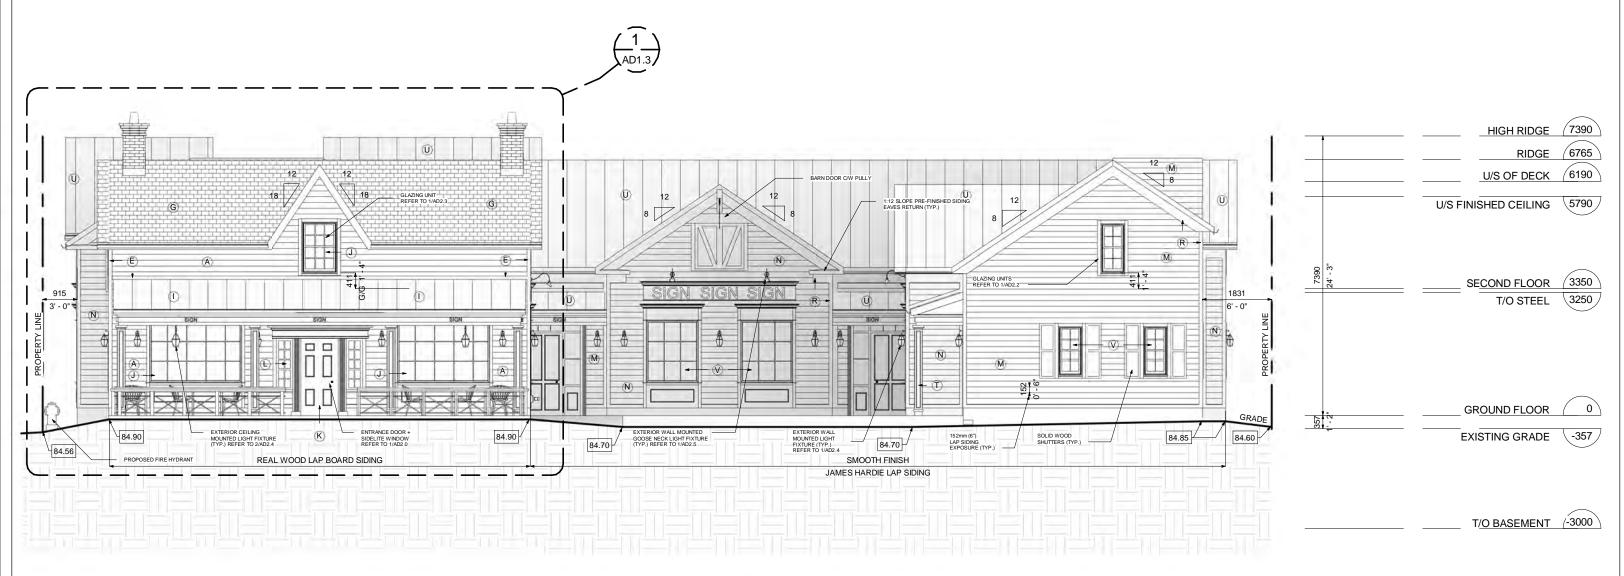

SOUTH ELEVATION AT STREET & COURTYARD BEYOND.

1:100






135 QUEEN STREET

Niagara-on-the-Lake, ON L0S 1J0

RE-ISSUED FOR 'SPA AMENDMENT APPLICATION'
SOUTH ELEVATION AT STREET & COURTYARD BEYOND

іап коас					
L4K 4R7		SCALE	REVISION NO.	JOB NO.	DRAWING NO.
669,7000 ect.on.ca chitect.ca	2017.12.08	1:100	R4	15624	AD1.1

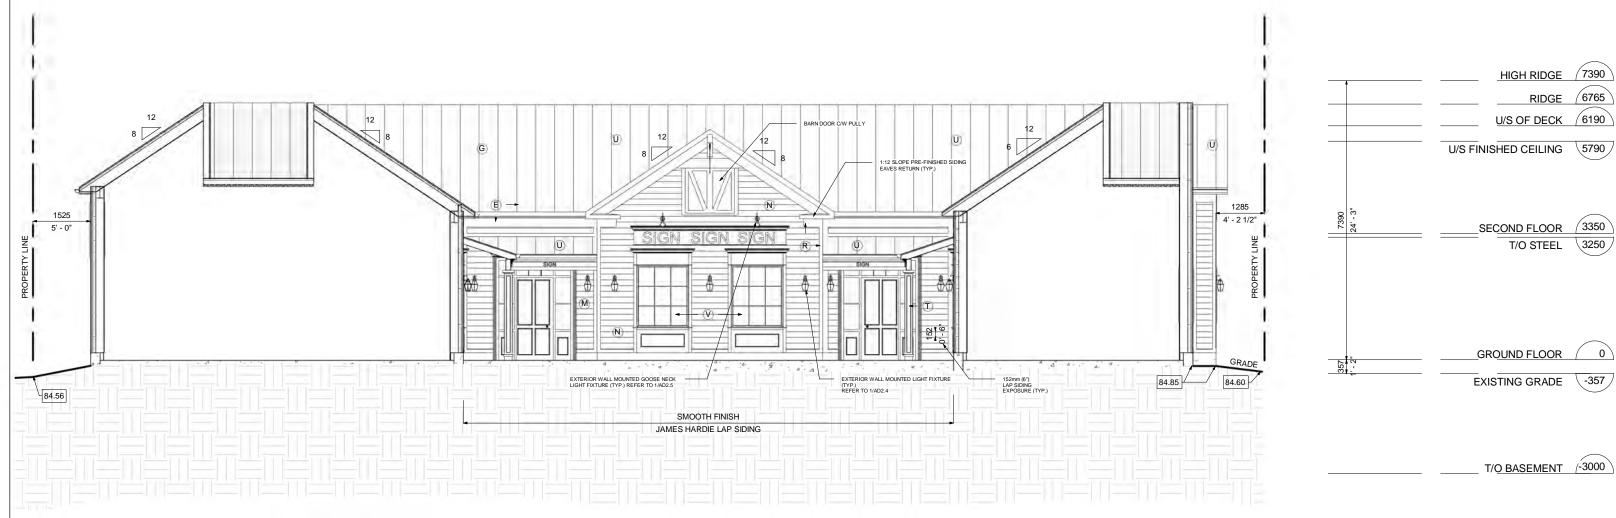

SOUTH ELEVATION AT COURTYARD

1:100





135 QUEEN STREET

Niagara-on-the-Lake, ON L0S 1J0

RE-ISSUED FOR 'SPA AMENDMENT APPLICATION'

7-3000 Langstaff Road
Vaughan, ON. L4K 4R7
DATE
SCALE

DATE	SCALE	REVISION NO.	JOB NO.	DRAWING NO.
2017.12.08	1 : 100	R4	15624	AD1.2








135 QUEEN STREET

Niagara-on-the-Lake, ON L0S 1J0


RE-ISSUED FOR 'SPA AMENDMENT APPLICATION'

SOUTH ELEVATION AT STREET

DATE	SCALE	REVISION NO.	JOB NO.	DRAWING NO.
017.12.08	1 : 50	R4	15624	AD1.3

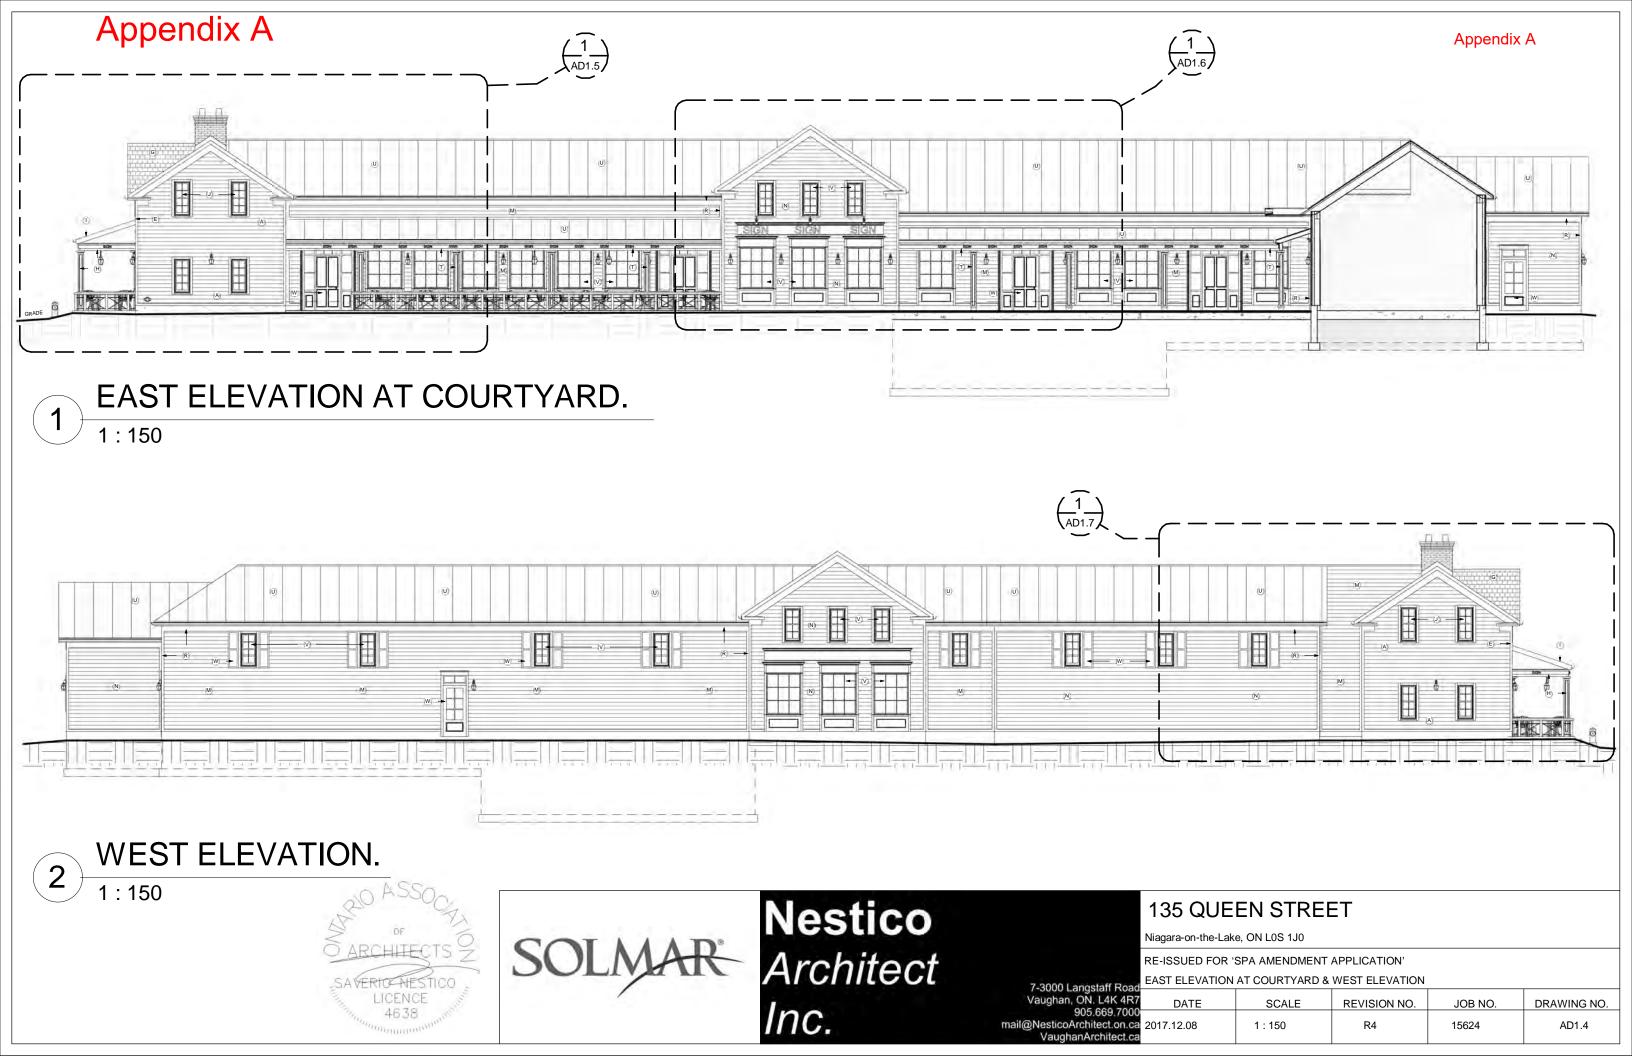



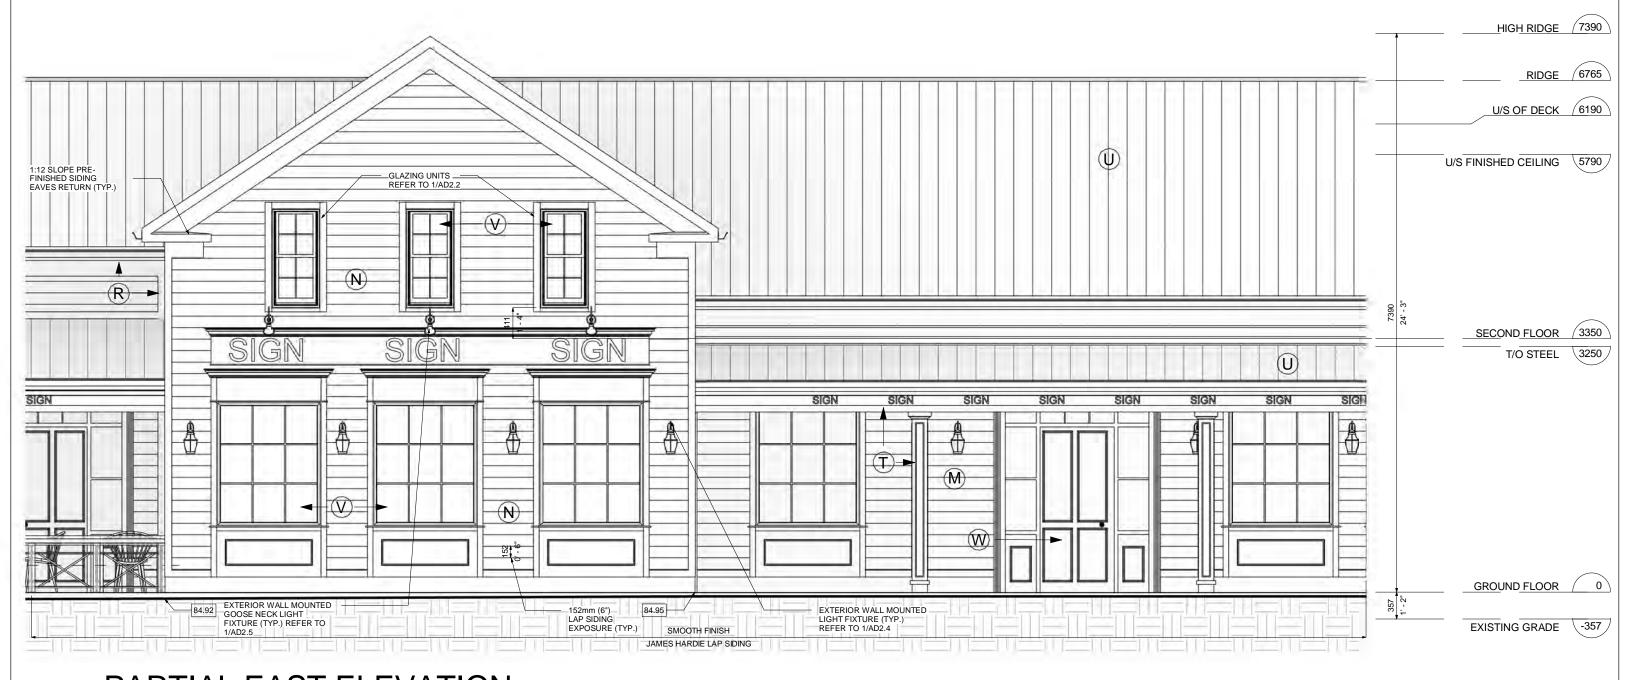

PARTIAL EAST ELEVATION.

1:50






135 QUEEN STREET

Niagara-on-the-Lake, ON L0S 1J0

RE-ISSUED FOR 'SPA AMENDMENT APPLICATION'

PARTIAL EAST ELEVATION

DATE	SCALE	REVISION NO.	JOB NO.	DRAWING NO.
2017.12.08	1 : 50	R4	15624	AD1.6

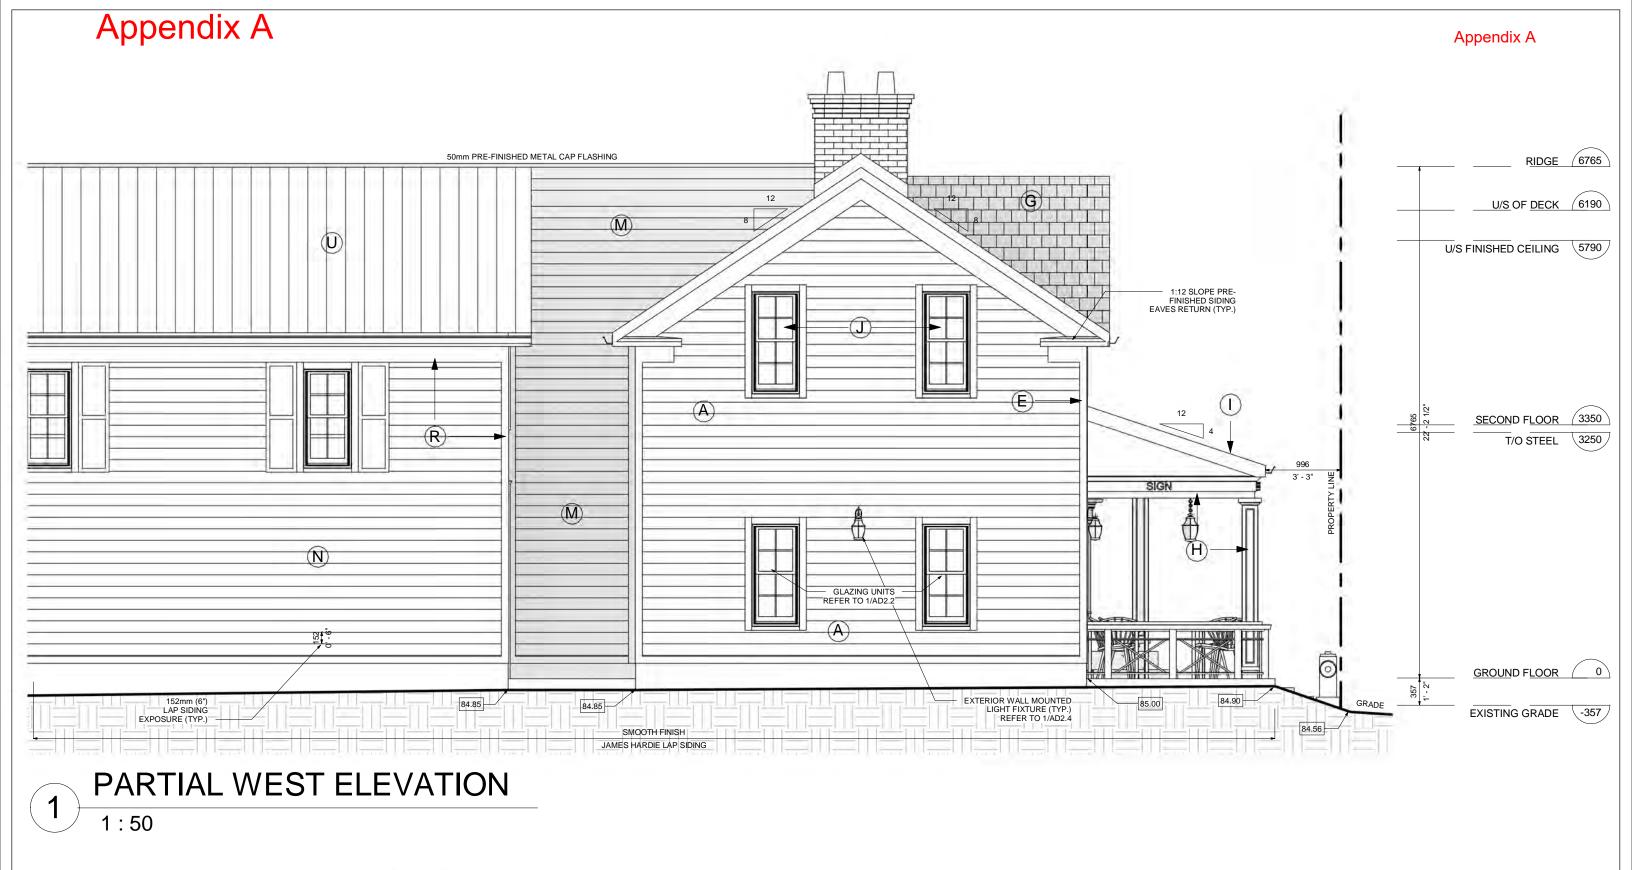





135 QUEEN STREET

Niagara-on-the-Lake, ON L0S 1J0

RE-ISSUED FOR 'SPA AMENDMENT APPLICATION'

PARTIAL WEST ELEVATION

DATE	SCALE	REVISION NO.	JOB NO.	DRAWING NO.
2017.12.08	1 : 50	R4	15624	AD1.7

T/O BASEMENT /-3000



WEST ELEVATION AT COURTYARD.

1:75

LICENCE



135 QUEEN STREET

Niagara-on-the-Lake, ON L0S 1J0

RE-ISSUED FOR 'SPA AMENDMENT APPLICATION' WEST ELEVATION AT COURTYARD

DATE	SCALE	REVISION NO.	JOB NO.	DRAWING NO
2017.12.08	1:75	R4	15624	AD1.8



EAST ELEVATION.

1:75






135 QUEEN STREET

Niagara-on-the-Lake, ON L0S 1J0

RE-ISSUED FOR 'SPA AMENDMENT APPLICATION'

EAST ELEVATION

DATE	SCALE	REVISION NO.	JOB NO.	DRAWING NO.
2017.12.08	1:75	R4	15624	AD1.9

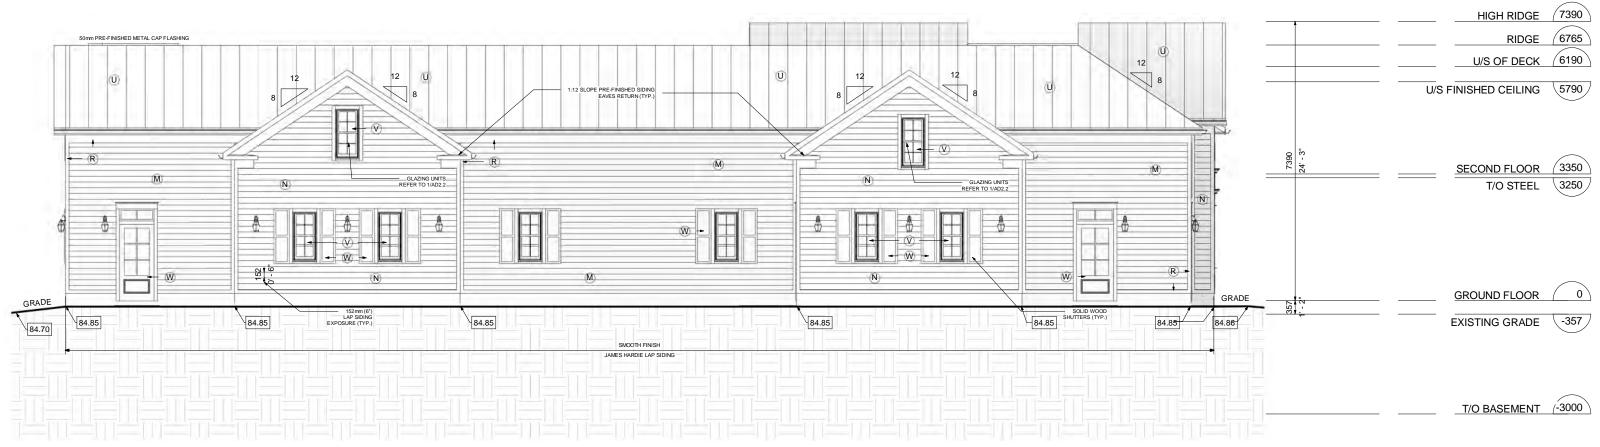

NORTH ELEVATION.

1:100





Nestico *Architect Inc.*

135 QUEEN STREET


Niagara-on-the-Lake, ON L0S 1J0


RE-ISSUED FOR 'SPA AMENDMENT APPLICATION'

7-3000 Langstaff Road
North ELEVATION

 DATE
 SCALE
 REVISION NO.
 JOB NO.
 DRAWING NO.

 2017.12.08
 1 : 100
 R4
 15624
 AD1.10

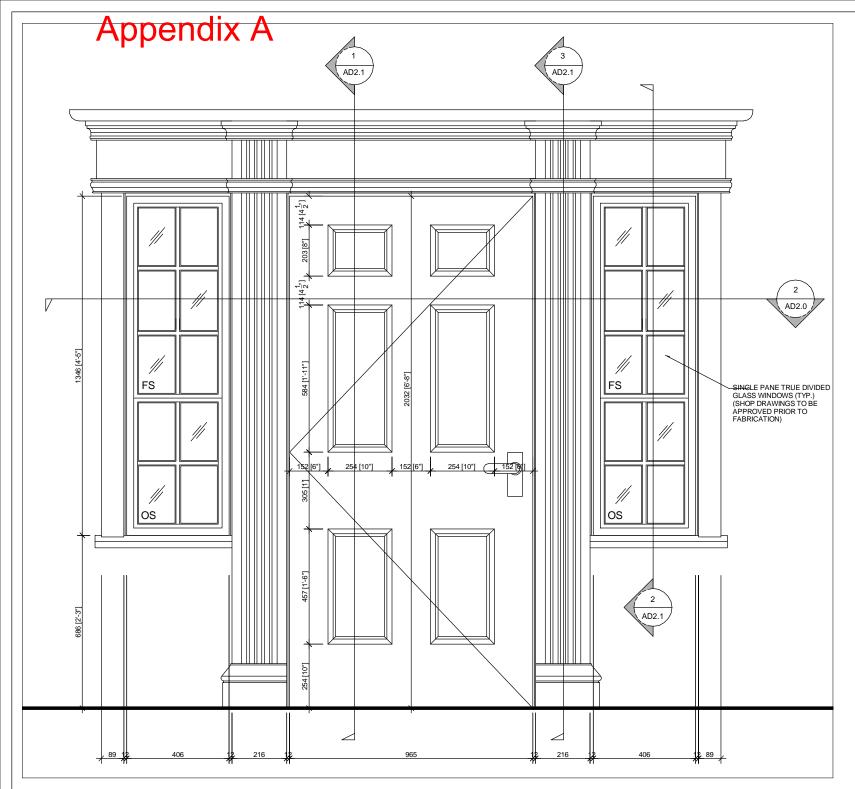

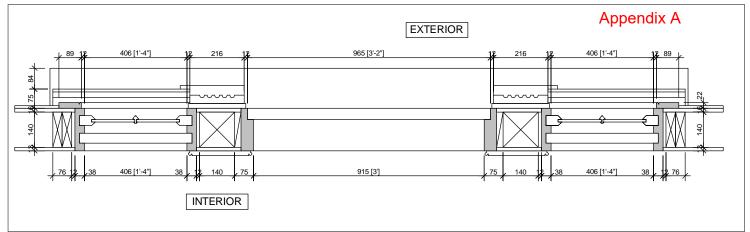

ENTRANCE DOOR PLAN

NOTE:

FS = FIXED SASH OS = OPERABLE SASH

ENTRANCE DOOR ELEVATION

1:15






135 QUEEN STREET

Niagara-on-the-Lake, ON L0S 1J0


RE-ISSUED FOR 'SPA AMENDMENT APPLICATION' SOUTH ENTRANCE DOOR & SIDELITE WINDOW DETAILS

Vaughan, ON. L4K 4R7	DATE	SCALE	REVISION NO.	JOB NO.	DRAWING NO.
905.669.7000 NesticoArchitect.on.ca VaughanArchitect.ca	2017.12.08	1 : 15	R4	15624	AD2.0

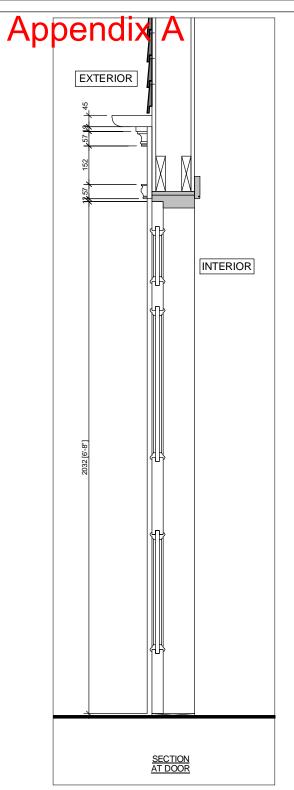

SECTION AT DOOR

1:15

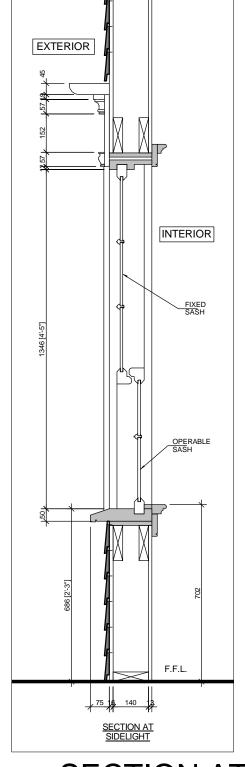

SECTION AT SIDELIGHT 1:15

INTERIOR 1:15

Appendix A

SECTION AT PILASTER

NOTE:

FS = FIXED SASH OS = OPERABLE SASH






Nestico
Architect
Inc.

135 QUEEN STREET

EXTERIOR

DOOR SECTION + PARTIAL WALL SECTIONS

SCALE REVISION NO. JOB NO. DRAWING NO. 1:15

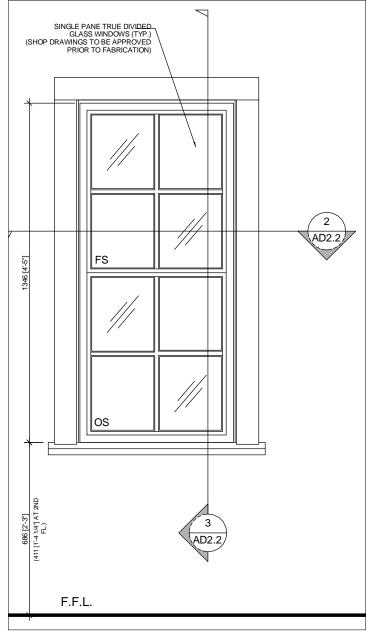


WINDOW 'B' ELEVATION

1:15

NOTE:

FS = FIXED SASH OS = OPERABLE SASH



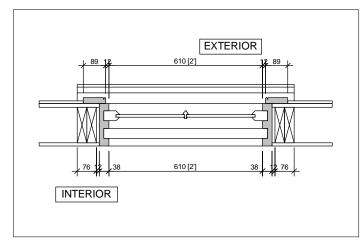

WINDOW 'B' PLAN 1:15

> **Nestico** Architect Inc.

WINDOW 'B' SECTION 3

1:15


EXTERIOR INTERIOR

135 QUEEN STREET

Niagara-on-the-Lake, ON L0S 1J0

RE-ISSUED FOR 'SPA AMENDMENT APPLICATION' EAST + WEST + NORTH + SOUTH WINDOW DETAILS

SCALE REVISION NO. JOB NO. DRAWING NO. 1:15

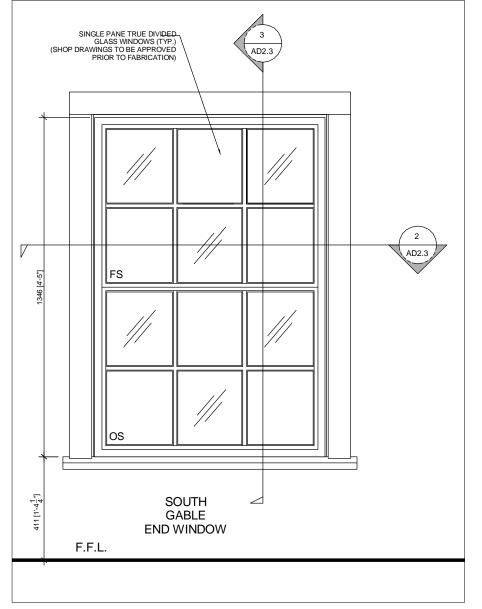

EXTERIOR INTERIOR

WINDOW 'A' ELEVATION

1:15

WINDOW 'A' PLAN

1:15

INTERIOR

EXTERIOR

WINDOW 'A' SECTION

1:15

NOTE:

FS = FIXED SASH OS = OPERABLE SASH





Nestico Architect Inc.

135 QUEEN STREET

Niagara-on-the-Lake, ON L0S 1J0

RE-ISSUED FOR 'SPA AMENDMENT APPLICATION' SOUTH GABLE END WINDOW DETAILS

SCALE REVISION NO. JOB NO. DRAWING NO. 1:15



EXTERIOR WALL MOUNTED LIGHT FIXTURE N.T.S



EXTERIOR CEILING HUNG LIGHT FIXTURE N.T.S





SOLMAR Architect Inc.

135 QUEEN STREET

Niagara-on-the-Lake, ON L0S 1J0

RE-ISSUED FOR 'SPA AMENDMENT APPLICATION' EXTERIOR LIGHT FIXTURES

SCALE REVISION NO. JOB NO. DRAWING NO. N.T.S



BARN LIGHT ELECTRIC

THE FRONTIER ANGLE SHADE ELECTRIC

CODE: BLE-G-ASFC-PC

FINISH CHART / FEATURES

POWDERCOAT FINISHES: DURABLE FINISH COLORS TO FIT ANY STYLE FROM TRADITIONAL TO RETRO TO MODERN

GOOSENECK ARMS: DOZENS OF STYLES, PROJECTIONS, DESIGNS AND ANGLES TO CHOOSE FROM

WIRE CAGE: ADD VINTAGE FLAVOR TO ANY SHADE WITH A WIRE CAGE **GUARD & GLASS:** PROTECT YOUR BULB AND ADD VINTAGE STYLE AND COLOR

DUSK-TO-DAWN PHOTOCELL: TURNS YOUR FIXTURE ON AT DUSK AND OFF AT DAWN!

SHADE SIZES: 08" SHADE: 8"W x 08"H

GOOSE NECK LIGHT FIXTURE N.T.S





135 QUEEN STREET

Niagara-on-the-Lake, ON L0S 1J0

RE-ISSUED FOR 'SPA AMENDMENT APPLICATION' GOOSE NECK LIGHT FIXTURE DETAILS

-3000 Langstan Road					
aughan, ON. L4K 4R7		SCALE	REVISION NO.	JOB NO.	DRAWING NO
905.669.7000 lesticoArchitect.on.ca VaughanArchitect.ca	2017.12.08	N.T.S	R4	15624	AD2.5

COLOUR SCHEDULE FOR 135 QUEEN ST. NOTL

- **HISTORICAL BUILDING:**
- LAP SIDING; WOODLAND CREAM, JH10-30
- FASCIA; ARCTIC WHITE, JH10-20
- SOFFIT: ARCTIC WHITE, JH10-20
- CROWN MOULDING; ARCTIC WHITE, JH10-20
- TRIM BOARDS AT CORNERS OF BUILDING; ARCTIC WHITE, JH10-20
- TRIM BOARDS AT WINDOW SURROUNDS: ARCTIC WHITE, JH10-20
- ROOF SHINGLES: GAF TIMBERLINE ULTRA HD. WEATHERED WOOD
- COLUMNS (SUPPORTING THE ROOFING STRUCTURE OVER FRONT DECK); ARCTIC WHITE, JH10-20
- STEEL ROOF, OVER DECK; CHARCOAL, QC306
- WINDOW FRAMES, SASHES, STILES + SILLS; ARCTIC WHITE, JH10-20
- FRONT DOOR: BENJAMIN MOORE LAFAYETTE GREEN. HC-135
- FRONT SIDELIGHT FRAMES, SASHES, STILES + SILLS; ARCTIC WHITE, JH10-20
- REMAINING PART OF BUILDING (NORTH OF HISTORICAL BUILDING)
- LAP SIDING; HEATHERED MOSS, JH50-20 & COUNTRYLANE RED, JH90-20
- FASCIA: SAILCLOTH, JH20-10
- SOFFIT: SAILCLOTH, JH20-10
- CROWN MOULDING; SAILCLOTH, JH20-10
- TRIM BOARDS AT CORNERS OF BUILDING; SAILCLOTH, JH20-10
- TRIM BOARDS AT WINDOW SURROUNDS; SAILCLOTH, JH20-10
- COLUMNS (SUPPORTING THE ROOFING STRUCTURE OVER COVERED AREAS): SAILCLOTH, JH20-10
- METAL ROOF, THROUGHOUT: CHARCOAL, QC306
- WINDOW + DOOR FRAMES, SASHES, STILES + SILLS; SAILCLOTH, JH20-10
- W. DOORS AND SHUTTERS; BENJAMIN MOORE LAFAYETTE GREEN, HC-135



COLOUR SCHEDULE





SOLMAR Architect Inc.

N.T.S


135 QUEEN STREET


Niagara-on-the-Lake, ON L0S 1J0

RE-ISSUED FOR 'SPA AMENDMENT APPLICATION' COLOUR SCHEDULE & COLOUR PALETTE

DATE	SCALE	REVISION NO.	JOB NO.	DRAWING NO.
00 ca 2017.12.08 ca	N.T.S	R4	15624	AD2.6



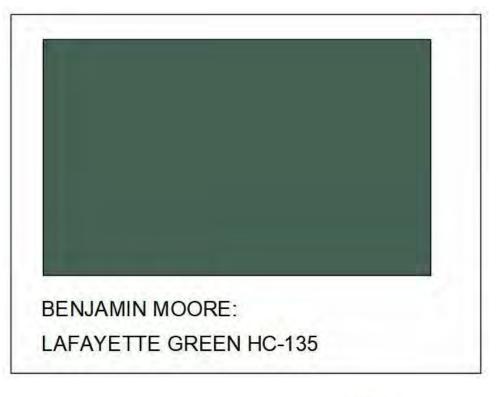

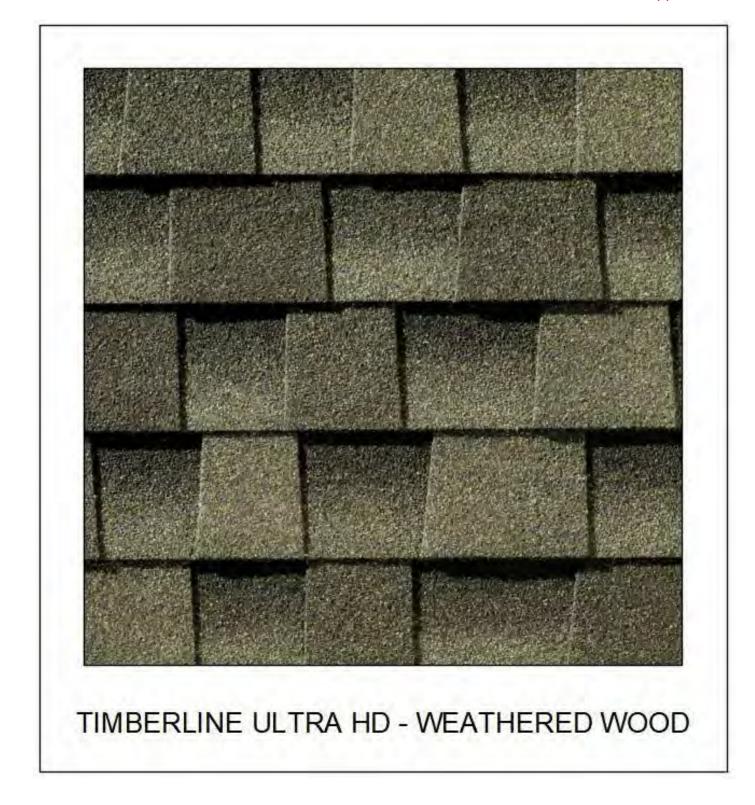





SOLMAR Architect Inc.

135 QUEEN STREET

Niagara-on-the-Lake, ON L0S 1J0

RE-ISSUED FOR 'SPA AMENDMENT APPLICATION' MATERIAL AND COLOUR SAMPLES

DATE	SCALE	REVISION NO.	JOB NO.	DRAWING NO.
2017.12.08		R4	15624	AD2.7

GENERAL NOTES

THE OWNER.

1. ALL DRAWINGS ARE IN METRIC SCALE. DIMENSIONS UNDER 1 MM ARE 7. CONTRACTOR SHALL COORDINATE HIS WORK WITH OTHER SHOWN AS A WHOLE NUMBER. ALL DIMENSIONS ARE GIVEN TO FACE OF CURB AND FACE OF FOUNDATION AND SITE WALLS, UNLESS OTHERWISE INDICATED.

2. CONTRACTOR SHALL OBTAIN ALL NECESSARY PROVINCIAL OR LOCAL MUNICIPAL PERMITS REQUIRED. ALL CONSTRUCTION SHALL CONFORM TO PROVINCIAL AND LOCAL MUNICIPAL STANDARDS AND CODES THAT PERTAIN TO THE SITE UNDER CONSTRUCTION.

3. CONTRACTOR SHALL ARRANGE FOR UTILITY STAKING PRIOR TO START OF CONSTRUCTION. IT IS THE CONTRACTORS RESPONSIBILITY TO VISIT THE SITE PRIOR TO CONSTRUCTION TO BECOME FAMILIAR WITH EXISTING CONDITIONS. IF ANY DISCREPANCIES EXIST BETWEEN THE DRAWINGS AND ACTUAL SITE CONDITIONS, CONTRACTOR SHALL BRING THIS TO THE ATTENTION OF THE LANDSCAPE ARCHITECT.

4. EXISTING UNDERGROUND UTILITIES SHOWN ON THE DRAWINGS ARE PLOTTED FROM ORIGINAL SITE DRAWINGS AND/OR SITE TOPOGRAPHIC SURVEY. EVERY ATTEMPT HAS BEEN MADE TO SHOW ALL UTILITY LINES WHERE THEY EXIST. CONTRACTOR SHALL USE EVERY PRECAUTION IN EXCAVATING SINCE ACTUAL UNDERGROUND UTILITIES MAY NOT BE AS SHOWN. CONTRACTOR SHALL MAKE HIMSELF THOROUGHLY FAMILIAR WITH ALL UNDERGROUND UTILITY LOCATIONS PRIOR TO ANY

EXCAVATION AND VERIFY LOCATIONS AND DEPTHS OF ALL UTILITIES. 5. CONTRACTOR SHALL PROVIDE HIS OWN LAYOUT, GRADING, STAKING, AND SURVEYING REQUIRED FOR CONSTRUCTION. REFER TO EXISTING SURVEY FOR BENCHMARKS AND OTHER EXISTING INFORMATION. CONTRACTOR SHALL FIELD VERIFY LAYOUT PRIOR TO CONSTRUCTION. 6. CONTRACTOR SHALL PROTECT ALL EXISTING AND NEW CONSTRUCTION FROM DAMAGE. SHOULD ANY DAMAGE OCCUR,

CONTRACTOR SHALL MAKE ALL NECESSARY REPAIRS AT NO COST TO

CONTRACTORS ON SITE.

8. PROVIDE BARRIERS OR OTHER PROTECTION TO KEEP VEHICULAR AND PEDESTRIAN TRAFFIC AWAY FROM CONSTRUCTION AREA AND OFF NEWLY PAVED AREAS BEFORE ASPHALT OR CONCRETE HAS CURED. DO NOT LEAVE ANY HOLES OPEN OVERNIGHT.

9. KEEP AREA OUTSIDE CONSTRUCTION ZONE CLEAN AND USABLE BY OTHERS AT ALL TIMES.

10. CONTRACTOR SHALL SUBMIT SAMPLES OF ALL PROPOSED MATERIALS FOR APPROVAL PRIOR TO PLACING ORDERS. 11. ALL WORK SHALL BE INSPECTED BY LANDSCAPE ARCHITECT PRIOR

TO PAYMENT APPROVAL. 12. CONTRACTOR SHALL PROVIDE MARKED-UP REDLINE PLANS SHOWING AS-BUILT SITE CONDITIONS TO THE LANDSCAPE ARCHITECT, PRIOR TO OBTAINING APPROVAL OF SUBSTANTIAL COMPLETION.

13. AT ALL EDGES OF EXISTING SIDEWALK OR CURB AGAINST WHICH NEW CONCRETE IS TO BE PLACED, SAWCUT AND REMOVE EXISTING CONCRETE BACK TO THE NEAREST CONTRACTION JOINT TO PROVIDE A SMOOTH TRANSITION TO THE NEW CONCRETE.

14. INSTALL ISOLATION JOINTS AT ALL LOCATIONS WHERE NEW CONCRETE MEETS EXISTING CONCRETE PAVEMENT.

LANDSCAPE NOTES

1. ALL PLANTING AND INSTALLATION IN RIGHT OF WAY SHALL MEET LOCAL MUNICIPAL STANDARDS AND SPECIFICATIONS.

2. LANDSCAPE CONTRACTOR SHALL COORDINATE HIS WORK WITH OTHER CONTRACTORS ON SITE TO MINIMIZE DAMAGE TO COMPLETED LAWN AND PLANT MATERIAL INSTALLATION. 3. IF ANY DISCREPANCY EXISTS BETWEEN THE QUANTITIES, SIZES OR

MATERIALS INDICATED ON THE PLAN AND SHOWN IN THE PLANT LIST, THE PLAN SHALL GOVERN. 4. IT IS THE LANDSCAPE CONTRACTORS RESPONSIBILITY TO VISIT THE SITE PRIOR TO START OF WORK, TO BECOME FAMILIAR WITH EXISTING

CONDITIONS AT THE SITE. 5. THE EARTHWORK CONTRACTOR IS RESPONSIBLE FOR ROUGH GRADING OF SUBGRADE BELOW LAWN AND LANDSCAPE AREAS. 6. THE LANDSCAPE CONTRACTOR IS RESPONSIBLE FOR RESPREADING TOPSOIL, FINE GRADING AND PREPARATION OF ALL LAWN AND LANDSCAPE AREAS.

7. LANDSCAPE CONTRACTOR SHALL PROVIDE SOIL TEST ANALYSIS FOR ALL SOIL USED ON PROJECT. COPIES OF SOIL ANALYSIS SHALL BE PROVIDED TO LANDSCAPE ARCHITECT PRIOR TO ANY LANDSCAPE CONSTRUCTION.

8. PRIOR TO SPREADING TOPSOIL, LANDSCAPE CONTRACTOR SHALL INSPECT AND ACCEPT ALL BASE GRADES. ANY DEVIATION FROM LINE AND GRADE INDICATED ON THE GRADING PLAN SHALL BE CORRECTED BY EARTHWORK CONTRACTOR BEFORE PLACING ANY TOPSOIL. 9. BEFORE PLANT MATERIAL INSTALLATION BEGINS, STAKE LOCATIONS OF NEW PLANT MATERIAL AND NOTIFY LANDSCAPE ARCHITECT FOR APPROVAL. NOTIFY LANDSCAPE ARCHITECT ONE WEEK MINIMUM PRIOR

10. CONTRACTOR SHALL NOTIFY LANDSCAPE ARCHITECT IF AREAS OF

TO TENTATIVE DATE OF STAKING.

11. ALL GRADING, UTILITY, AND IRRIGATION WORK SHALL BE COMPLETED PRIOR TO INSTALLATION OF PLANT MATERIAL AND LANDSCAPE MULCH. 12. ALL PLANT MATERIAL SHALL BE GROWN IN CLAY SOIL. ALL SHRUBS SHALL BE GROWN IN FIBRE POT CONTAINERS. ALL TREES SHALL BE NURSERY GROWN AND TRANSPLANTED USING THE BALL AND BURLAP

13. ALL SHRUBS AND CONIFEROUS PLANTINGS SHALL BE INSTALLED IN CONTINUOUS PLANTING BEDS.

14. ALL SHRUB BEDS ADJACENT TO LAWN AREAS SHALL HAVE A SPADED EDGE BORDER. BORDER SHALL BE CUT 80MM DEEP AT A 45° ANGLE, SO THERE IS A CLEAR AND WELL DEFINED SEPARATION BETWEEN THE PLANTING BEDS AND SODDED AREAS.

15. ALL SHRUB BED AREAS SHALL HAVE A MINIMUM 80MM THICK LAYER OF LANDSCAPE MULCH.


16. PRE-EMERGENT HERBICIDE SHALL BE USED UNDER MULCH IN ALL LARGE BED AREAS.

17. WHERE PROJECT SITE IS TO BE SODDED, CONTRACTOR SHALL PROVIDE NEW TOPSOIL AND SOD IN ANY ADJACENT RIGHT OF WAY FROM PROPERTY LINE TO BACK OF MUNICIPAL CURB.

18. CONTRACTOR SHALL WORK OVER LAWN AREAS THAT HAVE REMAINED PARTIALLY INTACT, TOP DRESSING WITH SOIL, SCARIFYING, AND SEEDING TO FORM A SMOOTH, FULL, EVEN LAWN, FREE OF BARE SPOTS, INDENTATIONS, AND WEEDS.

19. LANDSCAPE CONTRACTOR SHALL COORDINATE PLANTING SCHEDULE WITH IRRIGATION CONTRACTOR TO ENSURE PROPER WATERING OF PLANTED AND SEEDED AREAS AFTER INSTALLATION. LANDSCAPE CONTRACTOR SHALL COORDINATE PLANTING WITH IRRIGATION CONTRACTOR TO MINIMIZE CONFLICTS BETWEEN PLANTS AND

SPRINKLER HEADS AND LINES.

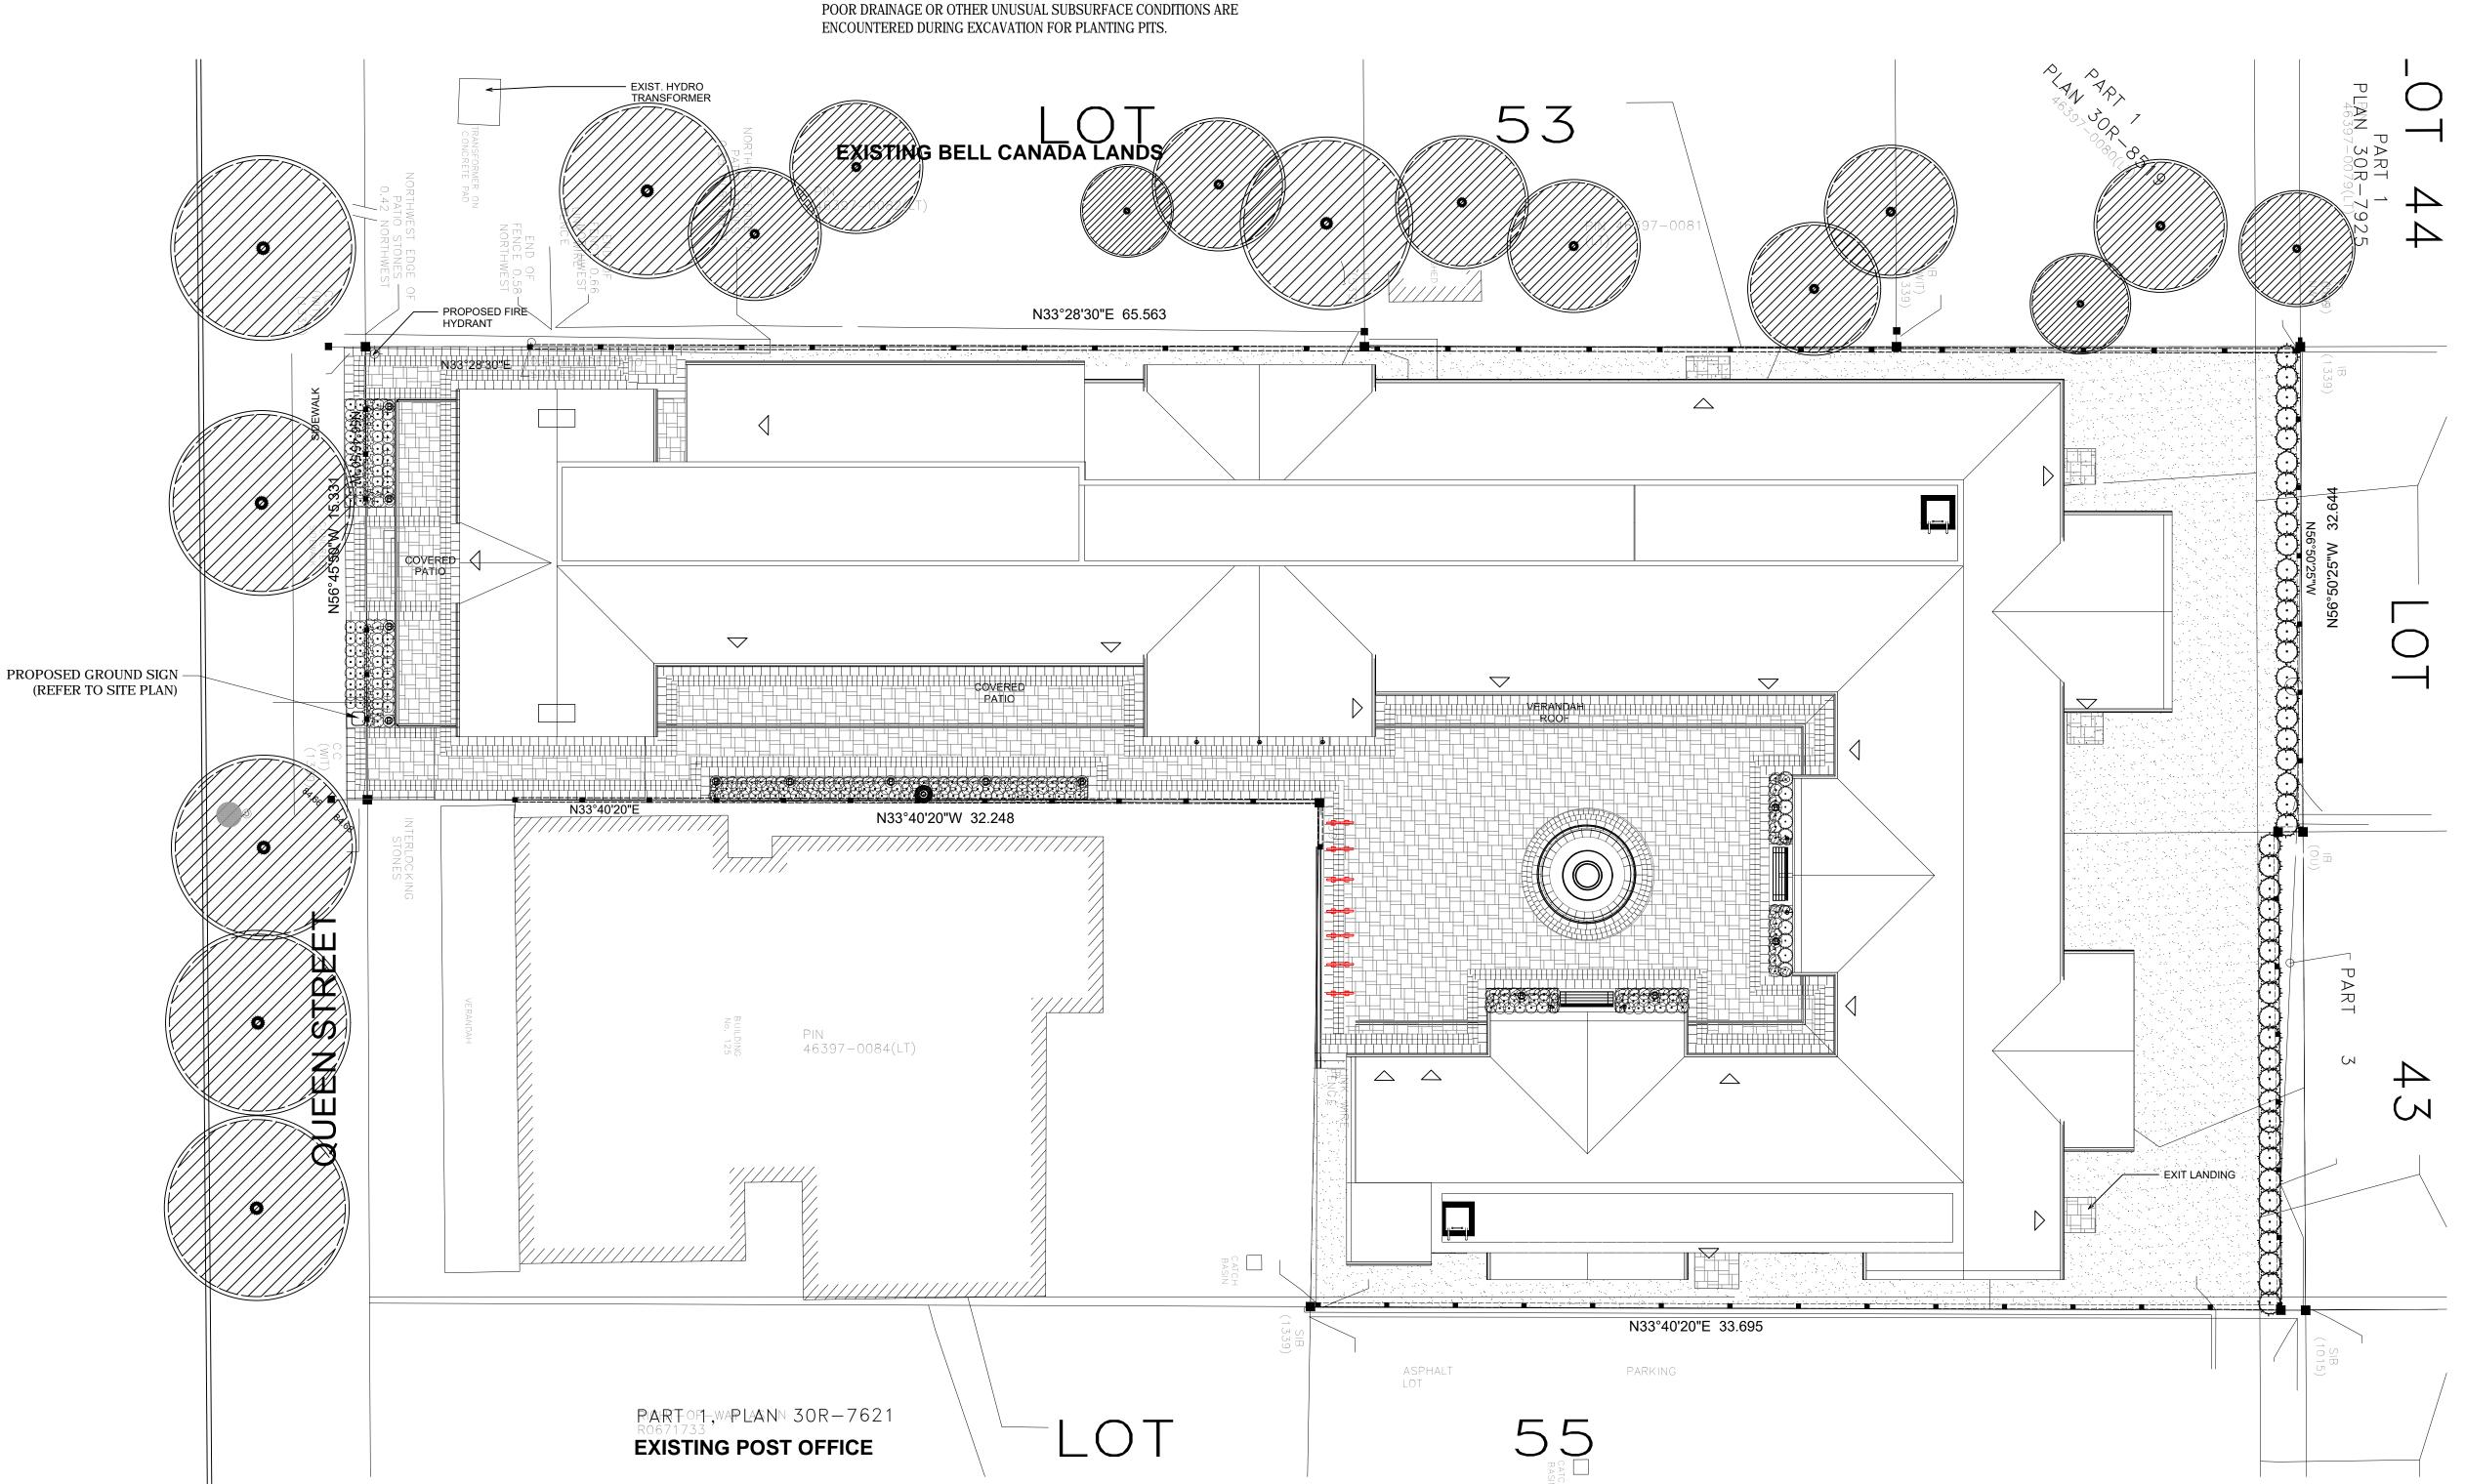




NOT FOR CONSTRUCTION

DRAWINGS LIST

L100 COVER SHEET L101 PLANTING PLAN L200 DETAIL REFERENCE PLAN

L301 DETAILS - PLANTING L302 DETAILS - PLANTING

L303 DETAILS - LIGHTING L304 DETAILS - LANDSCAPE

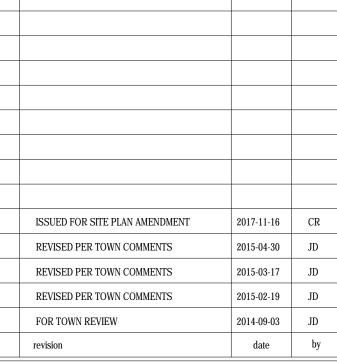

CONTRACTOR MUST VERIFY ALL DIMENSIONS ON THE JOB AND REPORT ANY DISCREPANCY TO THE LANDSCAPE ARCHITECT BEFORE PROCEEDING WITH THE

ALL DRAWINGS AND SPECIFICATIONS ARE INSTRUMENTS OF SERVICE AND THE PROPERTY OF THE LANDSCAPE ARCHITECT WHICH MUST BE RETURNED AT THE COMPLETION OF THE WORK. ALL DRAWINGS TO BE USED FOR CONSTRUCTION ONLY WHEN SIGNED BY THE LANDSCAPE ARCHITECT.



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PROPOSED COMMERCIAL DEVELOPMENT


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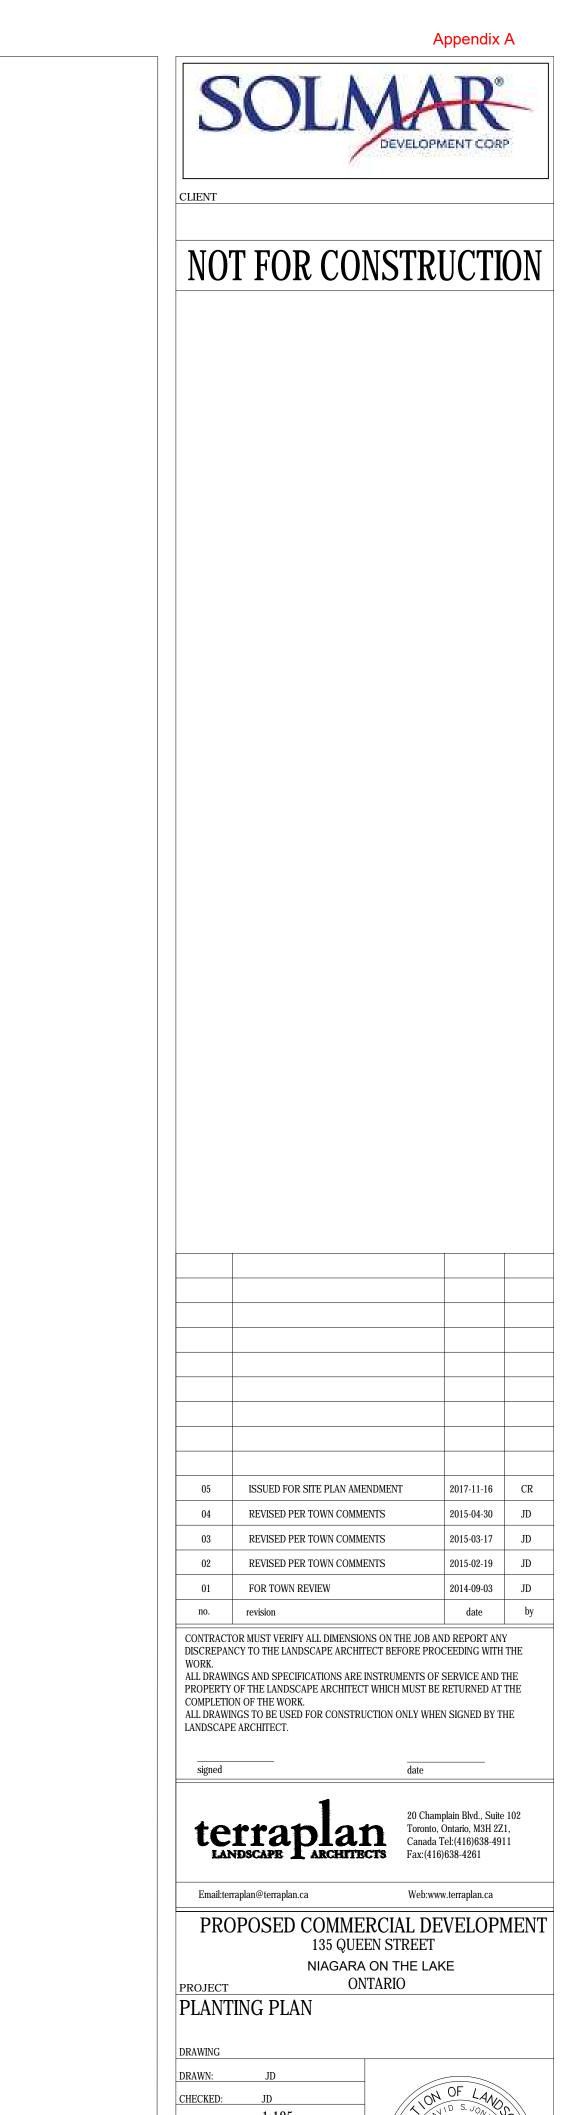
April 30, 2015

135 QUEEN STREET NIAGARA ON THE LAKE

ONTARIO LANDSCAPE PLAN - COVER SHEET

1:125 PROJECT NO.: 14-180




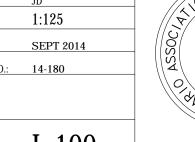

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PROJECT NO.: 14-180

April 30, 2015

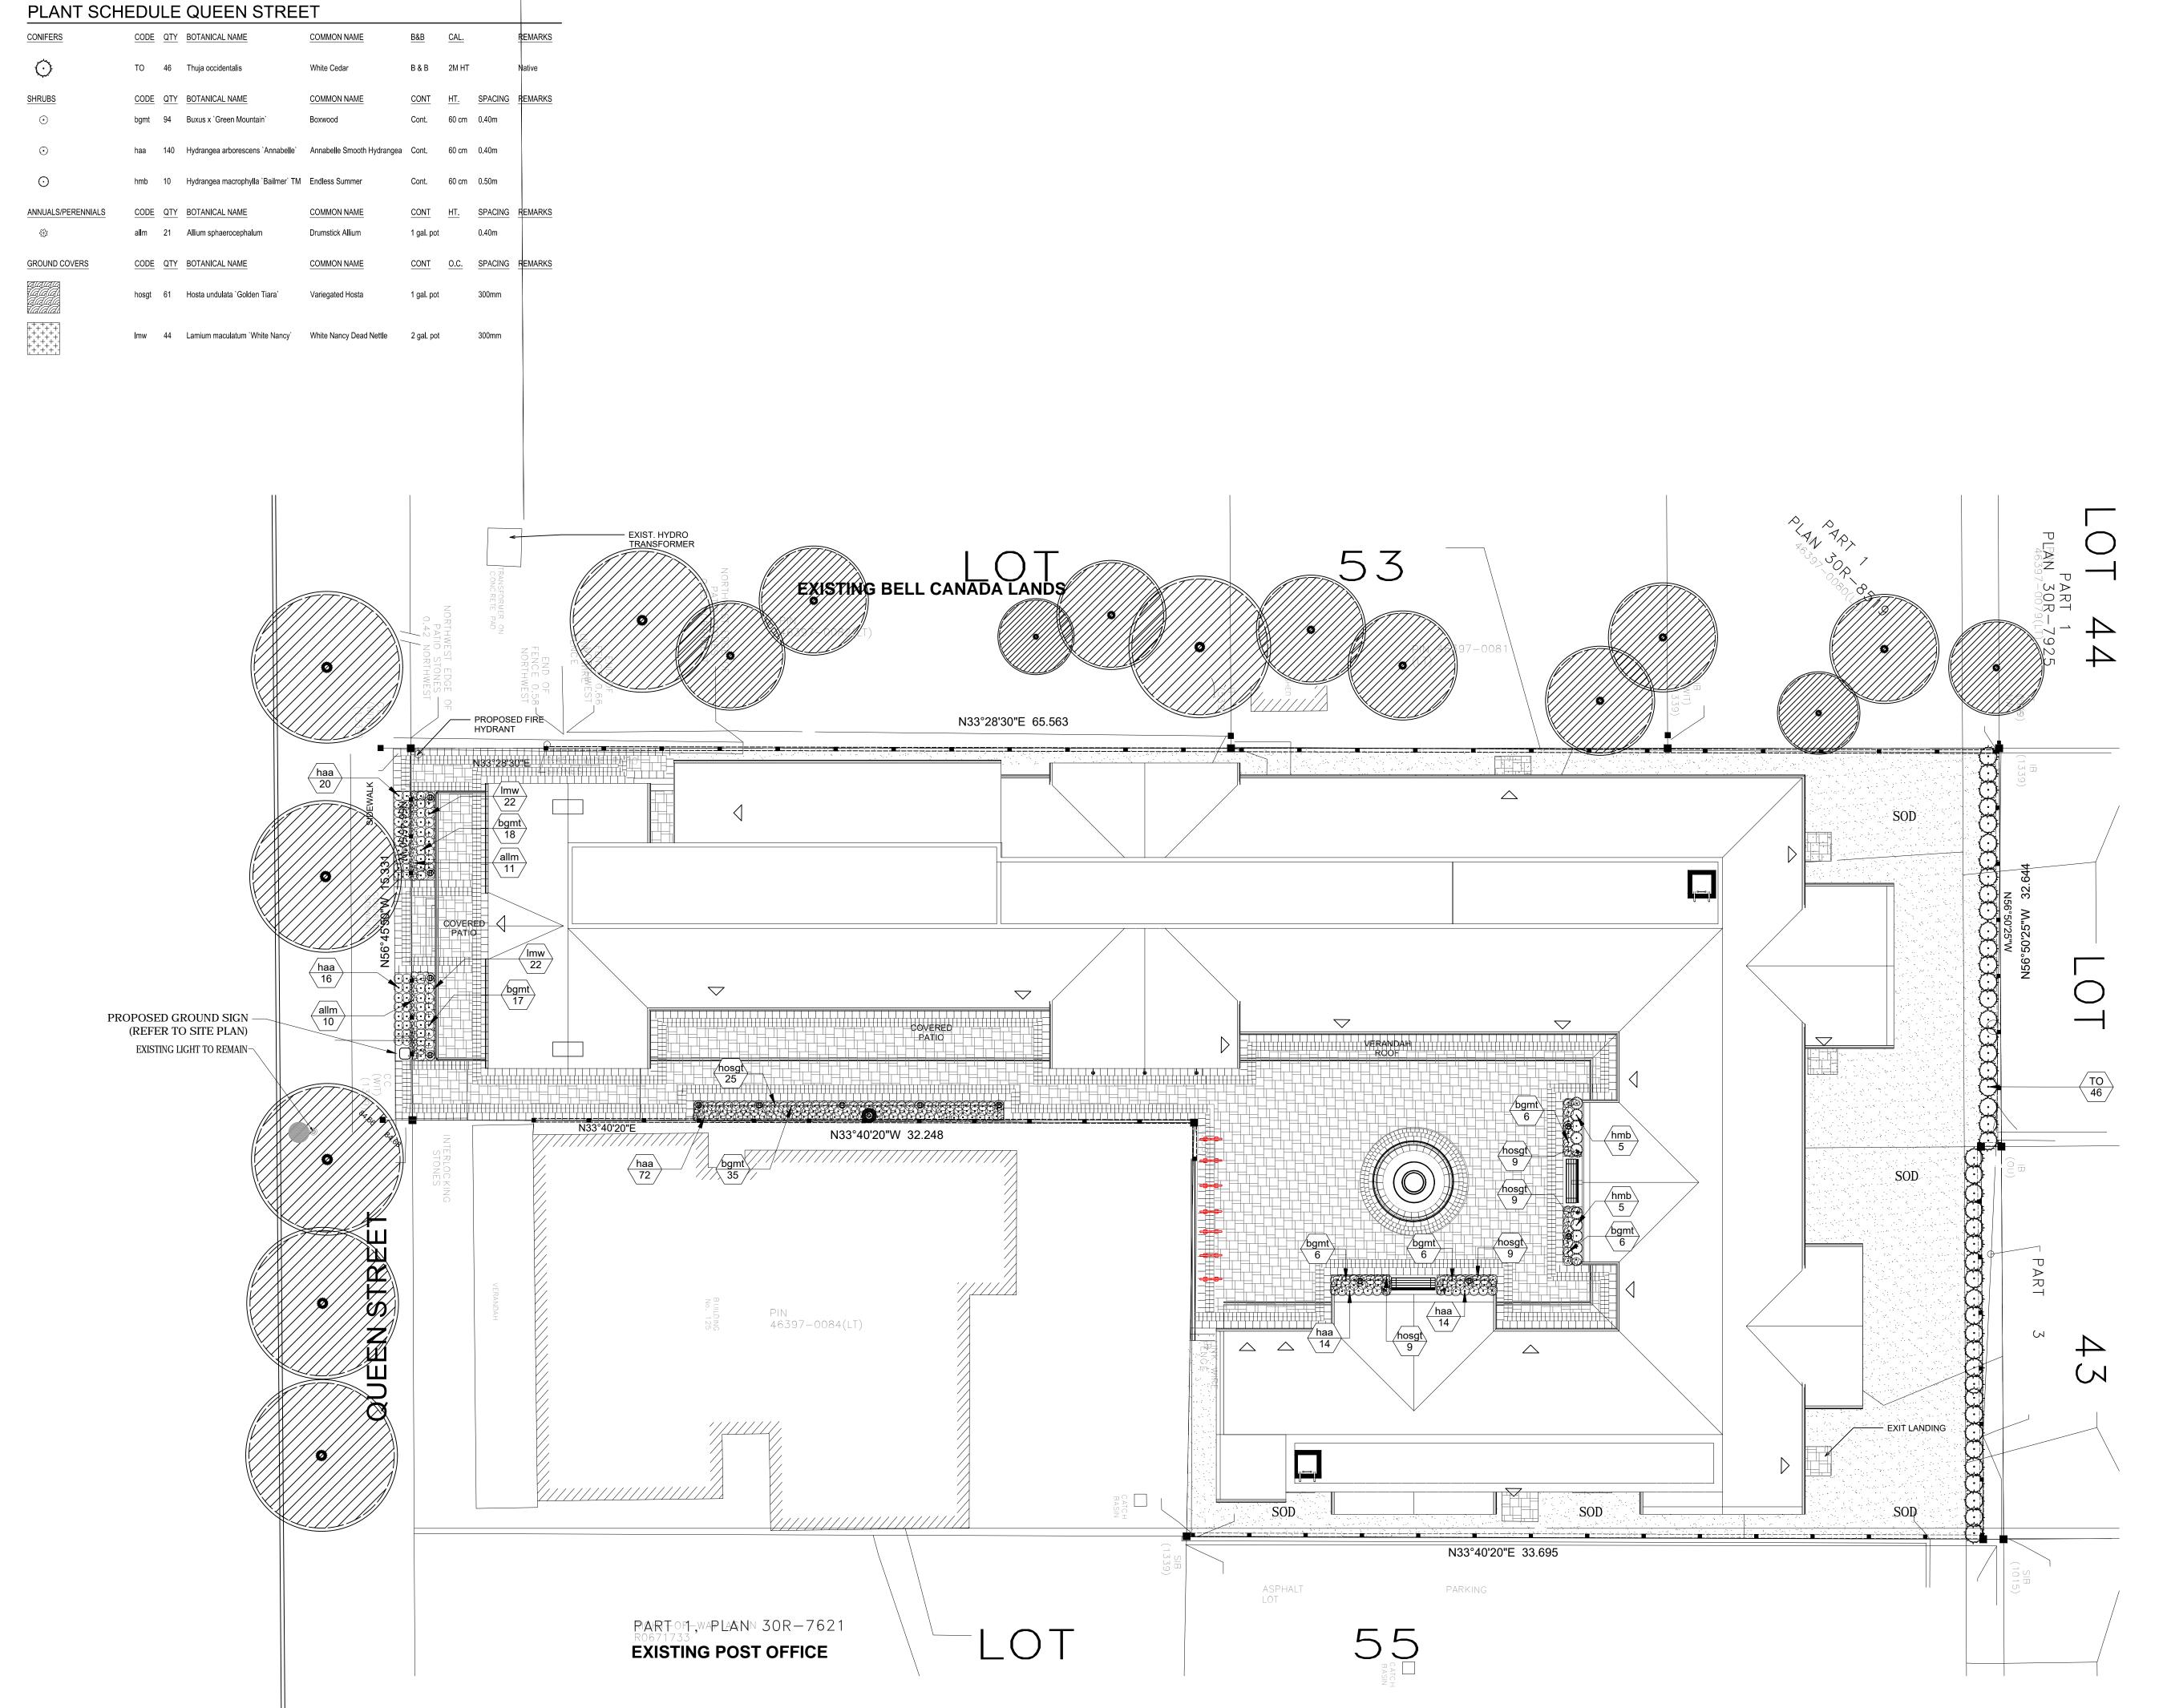


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NOT FOR CONSTRUCTION



05	ISSUED FOR SITE PLAN AMENDMENT	2017-11-16	CR
04	REVISED PER TOWN COMMENTS	2015-04-30	JD
03	REVISED PER TOWN COMMENTS	2015-03-17	JD
02	REVISED PER TOWN COMMENTS	2015-02-19	JD
01	FOR TOWN REVIEW	2014-09-03	JD
no.	revision	date	by
CONTRACT	OR MUST VERIFY ALL DIMENSIONS ON THE TOB AN	D REPORT ANY	7

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ALL DRAWINGS TO BE USED FOR CONSTRUCTION ONLY WHEN SIGNED BY THE LANDSCAPE ARCHITECT.
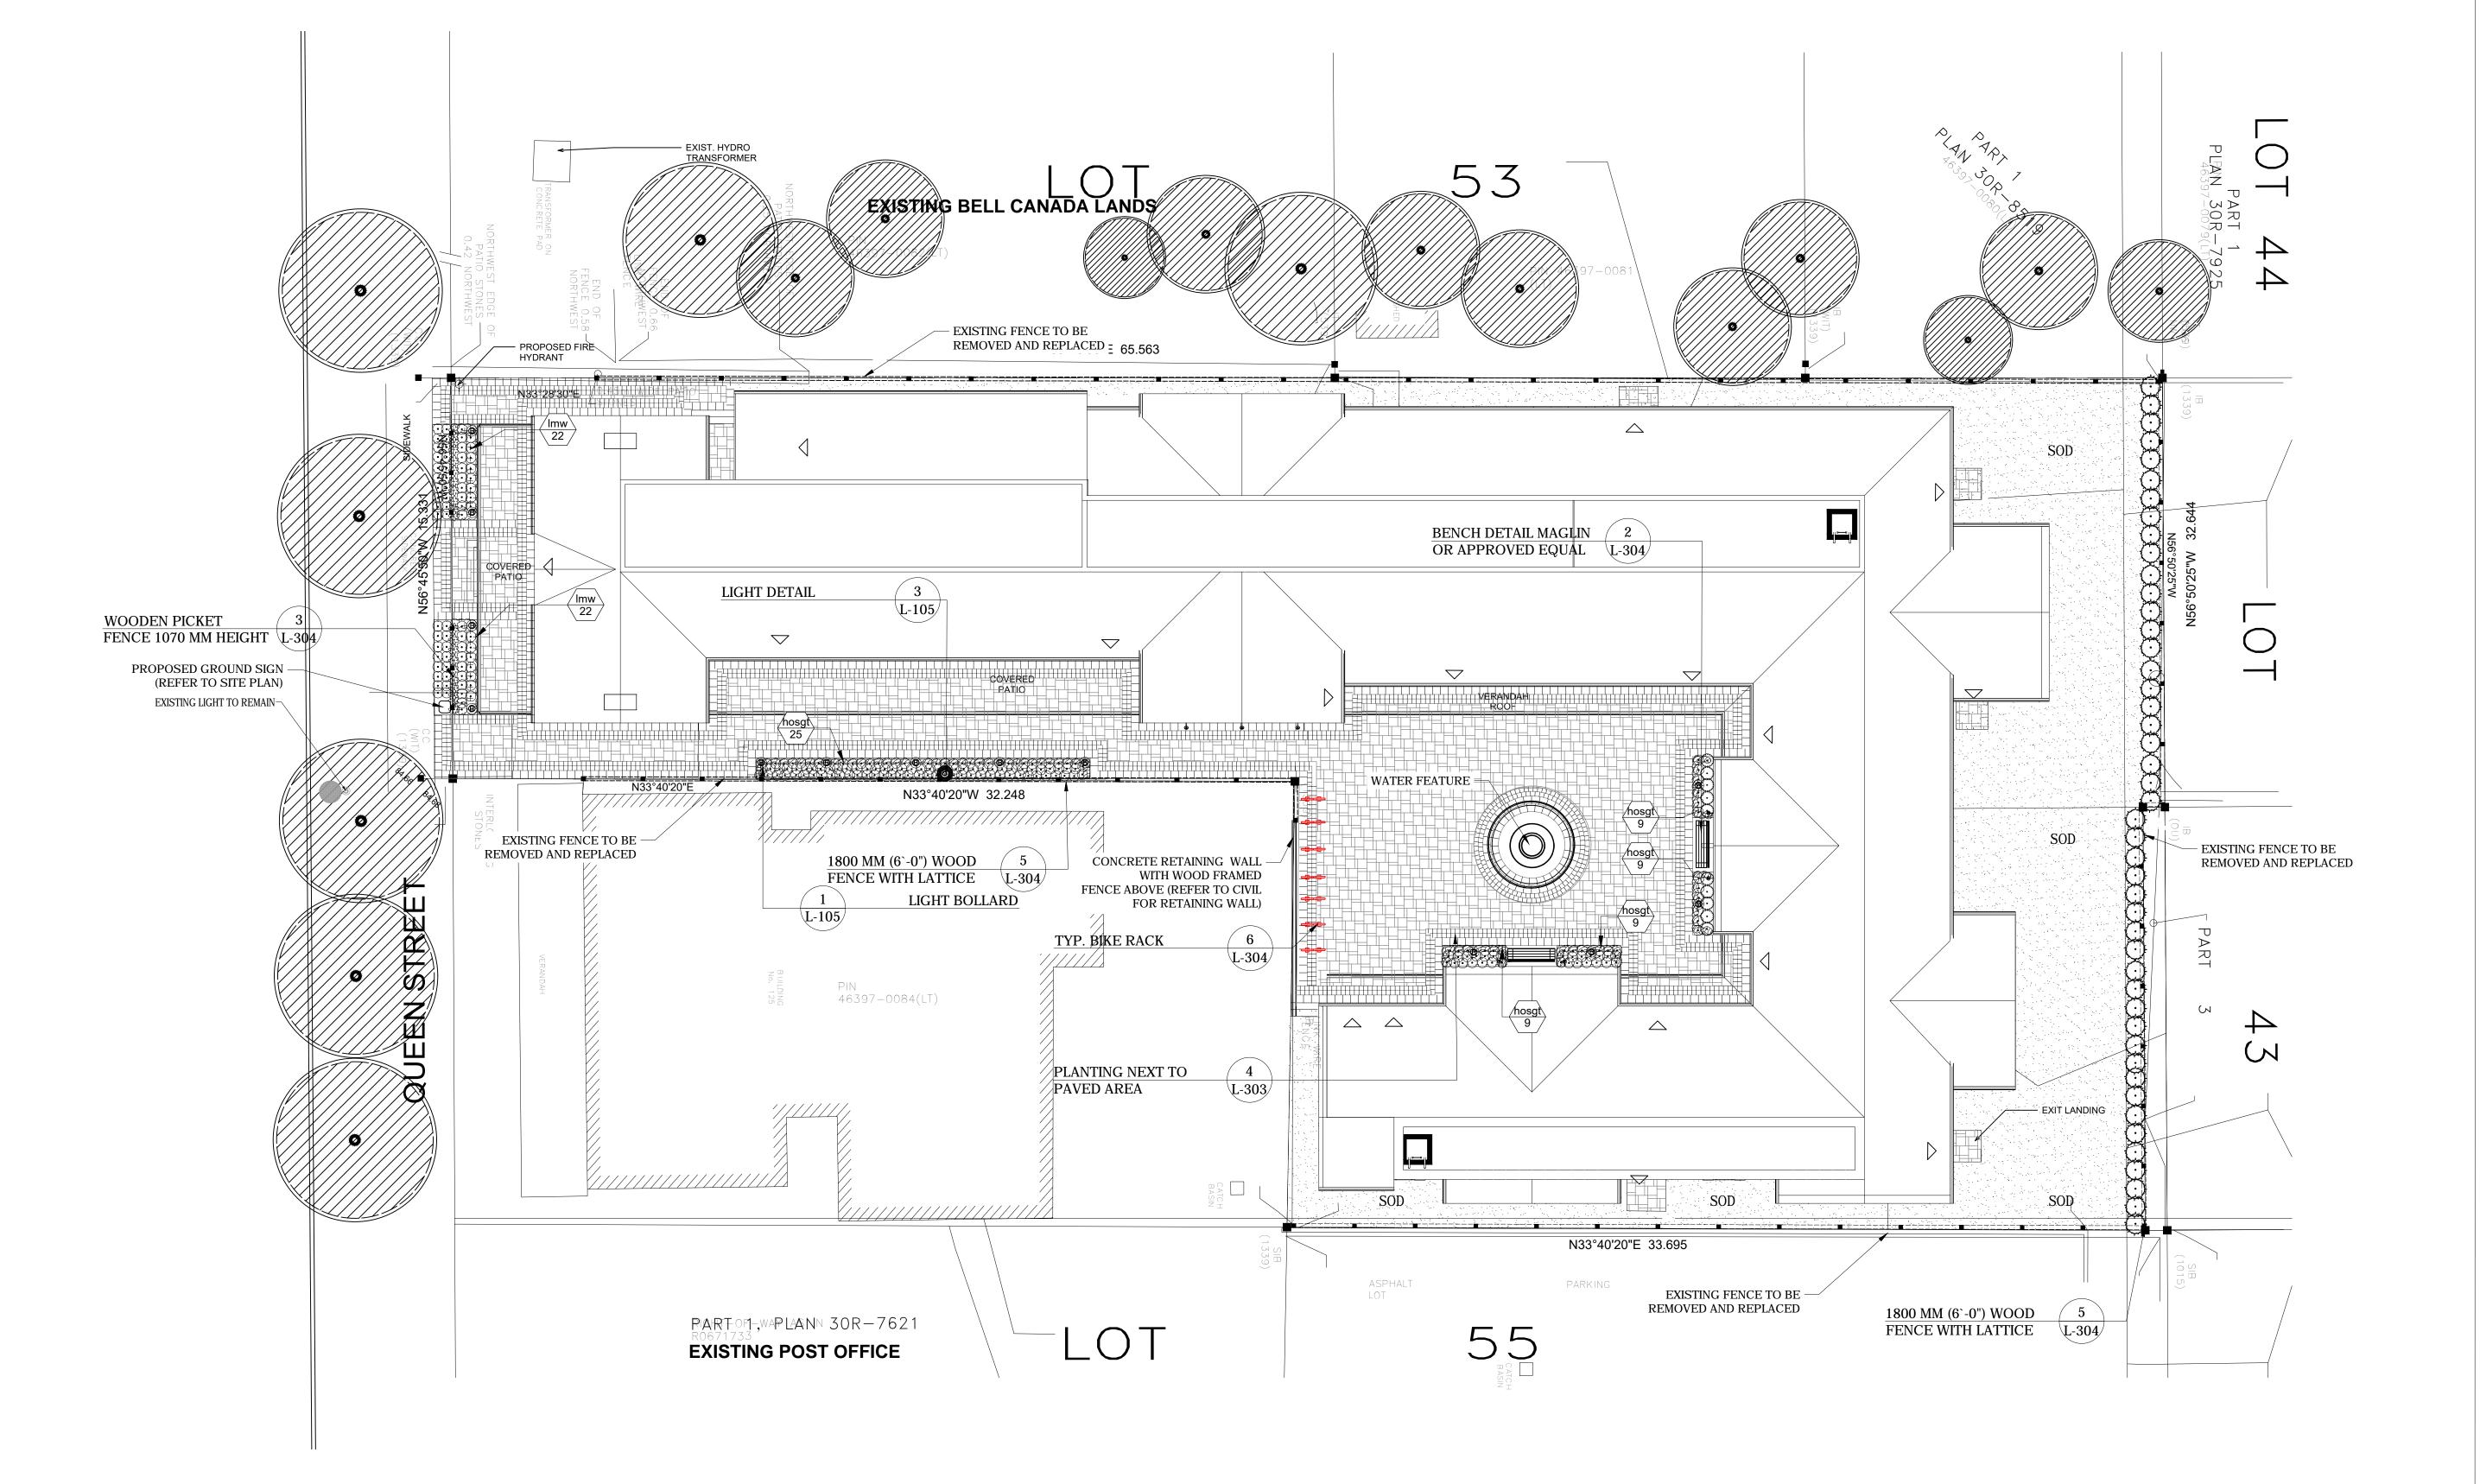
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PROPOSED COMMERCIAL DEVELOPMENT
135 QUEEN STREET
NIAGARA ON THE LAKE

OJECT ONTARIO

TAIL REFERENCE DI AN

DETAIL REFERENCE PLAN

DRAWING

DRAWN: JD

CHECKED: JD

SCALE: 1:125

DATE: SEPT 2014

PROJECT NO.: 14-180

L-200



CONTRACTOR MUST CONTACT ALL UTILITY COMPANIES FOR STAKE OUTS PRIOR TO ANY EXCAVATION OR PLANTING. ONTARIO. ALL LAWN AREAS SHALL RECEIVE A MINIMUM OF 100MM (4") OF TOPSOIL, AND SHALL BE ROUGH GRADING

ROUGH GRADE AND FILL AREAS TO ESTABLISH SUBGRADE AS REQUIRED. PROVIDE DRAINAGE PATTERN AS INDICATED ON DRAWINGS. ROUND SMOOTHLY ALL TOPS AND TOES OF SLOPES. COMPACT ALL AREAS TO 95% STANDARD PROCTOR DENSITY UNLESS SPECIFIED OTHERWISE. EXISTING TREES TO REMAIN ON SITE ARE TO BE PROTECTED AS DETAILED.

FINE GRADING

FINE GRADE ALL AREAS TO FINISHED GRADES AS SHOWN ON LAYOUT OR GRADING PLAN OR ARCHITECT'S SITE PLAN. PROVIDE UNIFORM SLOPES AWAY FROM THE BUILDING, UNLESS SPECIFIED OTHERWISE. SLOPES MAY NOT EXCEED 33 1/3% (3:1).

TOPSOIL FOR SODDED & SEEDED AREAS: Mixture of mineral particulates, micro organisms and organic matter which provides suitable medium for supporting intended plant

- .1 Soil texture based on The Canadian System of Soil Classification, to consist of
- 20 to 70% sand and contain 5 to 10% organic matter by weight. .2 Fertility: major soil nutrients present in following ratios:
- Nitrogen (N): 20 to 40 micrograms of available N per gram of topsoil. .2 Phosphorus (P): 10 to 20 micrograms of phosphate per gram of topsoil.
- .3 Potassium (K): 80 to 120 micrograms of potash per gram of topsoil. .4 Calcium, magnesium, sulphur and micro-nutrients present in balanced ratios to
- support germination and/or establishment of intended vegetation. .3 Ph value: 5.5 to 7.5.
- .4 Contain no toxic elements or growth inhibiting materials. .5 Free from:
- .1 Debris and stones over 25 mm diameter. .2 Course vegetative material, 10 mm diameter and 100 mm length, occupying more
- than 2% of soil volume.
- .6 Consistence: friable when mois .7 Stocked piled on site 'topsoil' must be tested by A&L Canada Laboratories East (519-457-2575), provide results for tests: STP1 and STEXT and a method of amending the soil to Terraplan for approval. All topsoil must meet the above specifications.

SPREADING OF TOPSOIL

SCALE=NO SCALE

SCARIFY THE SUBSOIL PRIOR TO THE SPREADING THE TOPSOIL. REMOVE ALL DEBRIS AND LEAVE A FINE-TEXTURED EVEN SURFACE. ALL TOPSOIL TO BE IMPORTED UNLESS PREVIOUSLY APPROVED BY LANDSCAPE ARCHITECT. OBTAIN APPROVAL FOR THE QUALITY OF ANY IMPORTED TOPSOIL BEFORE DELIVERY TO THE SITE.

USE SOD WHICH CONFORMS WITH THE SPECIFICATIONS OF THE NURSERY SOD GROWERS ASSOCIATION OF SODDED WITH #1 BLUEGRASS - FESCUE SOD. NO SOD SLOPES ARE TO EXCEED 3:1. SLOPE IN EXCESS OF THE CONTRACTOR SHALL BE RESPONSIBLE FOR CUTTING ALL SODDED AND SEEDED AREAS AT LEAST TWO

(2) TIMES BEFORE FINAL INSPECTION FOR ACCEPTANCE OF THE LANDSCAPE WORK.

APPLY THE FOLLOWING MINERAL FERTILIZER UNLESS SOILS TESTS SHOW OTHER REQUIREMENTS FOR

PLANT MATERIAL TO BE CLAY GROWN STOCK UNLESS OTHERWISE NOTED.

NITROGEN AND POTASH: 1. SODDED AREAS: INITIAL PLANTING: 20% NITROGEN, 0% PHOSPHORUS AND 15% POTASH (20-0-15) AT THE RATE OF 4.5 KG OVER 100 SQM (10 LBS OVER 1000 SQ. FT.). ON-GOING TURF MAINTENANCE, APPLY 16-0-8 (SUMMER AND FALL) APPLY AFTER THE 8th WEEK. 2. PLANTING BEDS - 7% NITROGEN, 7% PHOSPHORUS AND 7% POTASH (7-7-7) AT THE RATE OF 40 GRAMS (4 OZ.) FOR EVERY BUSHEL OF TOPSOIL.

PREPARATION OF PLANTING BEDS

ALL PLANT BEDS TO BE CONTINUOUS. EXCAVATE ALL PLANTING BEDS TO THE DEPTH AS INDICATED ON THE DRAWINGS AND DETAILS, MIN 600mm (2.0'). BACK FILL ALL PLANTING BEDS WITH A SOIL MIXTURE CONSISTING OF SIX (6) PARTS OF SAND LOAM. ONE (1) PART OF FINELY PULVERIZED PEAT MOSS, TWO (2) PARTS OF WELL-ROTTED MANURE AND THE MINERAL FERTILIZER AS SPECIFIED ABOVE. ALSO ADD .58 KILOS BONEMEAL/CUBIC METER OF PLANTING SOIL (1 LB./CUBIC YARD). PREPARE THE PLANTING BEDS FOR PLANTING BEFORE THE DELIVERY RETELET PLANTE MISTERIA SOTO CHENTER STATE CLAY OR WET IN NATURE, CONTACT THE LANDSCAPE ARCHITECT FOR INSTRUCTIONS OF A SUITABLE SOIL MIXTURE OR DRAINAGE DETAIL. FAILURE TO DO THIS MAY RESULT IN DELAY OF APPROVAL AND ACCEPTANCE.

ALL PLANT MATERIAL SHALL CONFORM TO THE STANDARDS OF THE LANDSCAPE ONTARIO HORTICULTURAL TRADES ASSOCIATION (LOHTA) FOR SIZE AND SPECIES.

ALL SHRUB AND TREE MATERIAL SHALL BE CONTAINER GROWN, POTTED, S/B OR B/B, UNLESS OTHERWISE NOTED. BARE ROOT PLANTING SHALL BE ACCEPTABLE FOR CERTAIN SPECIES DURING EARLY SPRING OR LATE FALL PLANTING SEASON. CONTRACTOR SHALL MAKE REQUESTS FOR ROOT CONDITION SUBSTITUTION IN WRITING TO THE LANDSCAPE ARCHITECT PRIOR TO COMMENCEMENT OF PLANTING OPERATIONS. ALL

SODDED AREAS AND PLANTING BED

CONTRACTOR TO INSTALL NEW SOD AND NEW TOPSOIL AS PER SPECIFICATIONS AND GENERAL NOTES THROUGHOUT THE SITE AS DESIGNED. NEW TOPSOIL AND SOD SHALL EXTEND THROUGH THE MUNICIPAL BOULEVARD TO THE REAR OF THE MUNICIPAL CURB.

ALL PLANTING BEDS THAT ARE SURROUNDED BY SOD SHOULD BE CUT AND EDGED AT A 45° ANGLE, SO THERE IS A CLEAR AND WELL DEFINED SEPARATION BETWEEN THE PLANTING BEDS AND SODDED AREAS.

PLANT MATERIAL INSTALLATION

ALL TREES, SHRUBS AND GROUND COVERS SHALL BE PLANTED AS DETAILED AND AS SHOWN ON THE PLANTING PLAN. ALL BEDS TO RECEIVE A COVER OF CLEAN MULCH TO A DEPTH OF 75mm(3"). FOR GUYING AND STAKING TREES, REFER TO PLANTING DETAILS. WRAP ALL DECIDUOUS TREES UNDER EXPERIENCED SUPERVISION ONLY TO THE SPECIFICATIONS OF THE LANDSCAPE ONTARIO HORTICULTURAL TRADES ASSOCIATION (LOHTA). PLANT MATERIAL SIZES AND CONDITIONS ARE TO BE AS INDICATED ON THE LANDSCAPE DRAWING.

THE INDIVIDUAL PLANT GROUPING TOTAL AS ILLUSTRATED ON THE PLANTING PLAN SUPERSEDES THE ESTIMATED QUANTITY ON THE MASTER PLANT LIST. CONTRACTOR MUST REPORT ANY DISCREPANCIES TO THE LANDSCAPE ARCHITECT IN WRITING BEFORE COMMENCING ANY WORK. CONTRACTOR WILL ASSUME FULL RESPONSIBILITY IF LANDSCAPE ARCHITECT IS NOT NOTIFIED OF DISCREPANCIES.

* MULCH - SHREDDED PINE MULCH BY "GRO BARK" OR APPROVED EQUAL. LANDSCAPE ARCHITECT TO APPROVE MULCH BEFORE INSTALLATION. GENERAL MAINTENANCE

PROPER MAINTENANCE PROCEDURES ARE TO BE FULLY ADMINISTERED FOR ALL NEWLY CONSTRUCTED LANDSCAPE WORK, IN ACCORDANCE WITH LANDSCAPE ONTARIO SPECIFICATIONS (SECTION 1E -MAINTENANCE WORK). THIS SHALL APPLY ONLY DURING THE CONSTRUCTION PERIOD, UNLESS OTHERWISE SPECIFIED. CONTRACTOR IS RESPONSIBLE FOR MAINTENANCE OF SOD AND PLANTING UNTIL FINAL ACCEPTANCE BY LANDSCAPE ARCHITECT RODENT PROTECTION — THE CONTRACTOR SHALL BE RESPONSIBLE FOR THE PROTECTION OF ALL TREES AND SHRUBS FOR WINTER PROTECTION AND FROM RODENT INJURY FOR THE DURATION OF THE GUARANTY PERIOD. PROTECTIVE GUARDS SHALL BE EMPLOYED AROUND ALL DECIDUOUS TREES. GUARDS TO BE 150MM DIA. PVC PIPE OR AS MUNICIPAL GUIDELINES. GUARDS SHALL BE INSTALLED PRIOR TO THE APPLICATION OF THE MULCH AND SHOULD BE PLACED A MINIMUM OF 50MM (2") OUT FROM THE TREE

TRUNK ON ALL SIDES. ALL SHRUBS AND CONIFEROUS TREES SHALL HAVE AN APPLICATION OF "SKOOT" OR APPROVED EQUIVALENT RODENT FORMULA, TO BE APPLIED AT THE END OF OCTOBER. FOLLOW MANUFACTURER'S DIRECTIONS FOR APPLICATION.

GENERAL REQUIREMENTS

USE ABOVE SPECIFICATIONS IN CONJUNCTION WITH THE GENERAL LANDSCAPE SPECIFICATIONS OF THE LANDSCAPE ONTARIO HORTICULTURAL TRADES ASSOCIATION (LOHTA) AND THE NURSERY SOD GROWERS ASSOCIATION OF ONTARIO. USE ONLY PLANT MATERIAL TRUE TO NAME, SIZE AND GRADE AS SPECIFIED ON PLANTING PLAN; PROVIDE SUFFICIENT LABELS OR MARKINGS TO INDICATE CLEARLY THE VARIETY, SIZE AND GRADE OF EACH SPECIMEN OR BUNDLE.

OBTAIN APPROVAL FOR SUBSTITUTIONS AS TO VARIETY, SIZE OR GRADE FROM THE LANDSCAPE ARCHITECT. USE ONLY NURSERY STOCK GROWN UNDER PROPER HORTICULTURAL PRACTICES, VIABLE, FREE FROM PEST AND DISEASE AND UNDAMAGED. CHECK LOCATIONS AND OBTAIN STAKEOUTS OF ALL UTILITY LINES BEFORE EXCAVATION. OBTAIN ALL NECESSARY PERMITS BEFORE COMMENCEMENT OF CONSTRUCTION. REPORT IN WRITING ANY DISCREPANCIES IN THE DRAWINGS, SPECIFICATIONS AND CONTRACT DOCUMENTS TO THE LANDSCAPE ARCHITECT BEFORE THE END OF THE BIDDING PROCESS AND COMMENCEMENT OF CONSTRUCTION. THESE SPECIFICATIONS MAY BE SUPERSEDED BY ADDITIONAL SPECIFICATIONS SET OUT IN THE TENDER DOCUMENTS. CONTRACTOR TO REVIEW ALL DOCUMENTS.

GUARANTEE PERIOD

PROVIDE ONE FULL YEAR GUARANTEE ON ALL LANDSCAPE WORK FROM DATE OF FINAL ACCEPTANCE BY LANDSCAPE ARCHITECT. GUARANTEE PERIOD MAY BE EXTENDED TO TWO FULL YEARS DEPENDING ON MUNICIPAL STANDARDS. CONTRACTOR TO VERIFY WITH OWNER AND LANDSCAPE ARCHITECT.

STAKED B&B CONIFEROUS TREE PLANTING DETAIL

-SHRUB (DO NOT PRUNE, STAKE, OR WRAP

SHRUBS UNLESS DIRECTED TO DO SO BY

CROWN OF ROOT BALL FLUSH WITH FINISH

GRADE LEAVING TRUNK FLARE VISIBLE AT

(IF PLANT IS SHIPPED WITH A WIRE BASKET

PLACES AND FOLD DOWN 200mm INTO

AROUND THE ROOT BALL. CUT WIRE IN FOUR

70mm DEPTH AFTER SETTLEMENT, MULCH

PLACE MULCH IN CONTACT WITH SHRUB

-PLANTING MIXTURE BACKFILL

LAYER TO EDGE OF PLANTING BED. DO NOT

-100mm HIGH SOIL SAUCER BEYOND EDGE OF

TWO 21 GRAM FERTILIZER TABLETS FOR EACH

— TAMPED PLANTING MIXTURE AROUND BASE OF

ROOTS HALFWAY UP ON BALL

-ROUGHEN EDGES OF PLANTING PIT

-UNEXCAVATED OR EXISTING SOIL

SHRUB (DISTRIBUTE TABLETS EQUALLY AMONG

SHRUBS IN BED). PLACE 30-50mm FROM EDGE OF

-REMOVE ALL TWINE, ROPE, WIRE, BURLAP AND


PLASTIC WRAP FROM TOP HALF OF ROOT BALL

LANDSCAPE ARCHITECT)

THE TOP OF THE ROOT BALL

PLANTING HOLE)

ROOT BALL

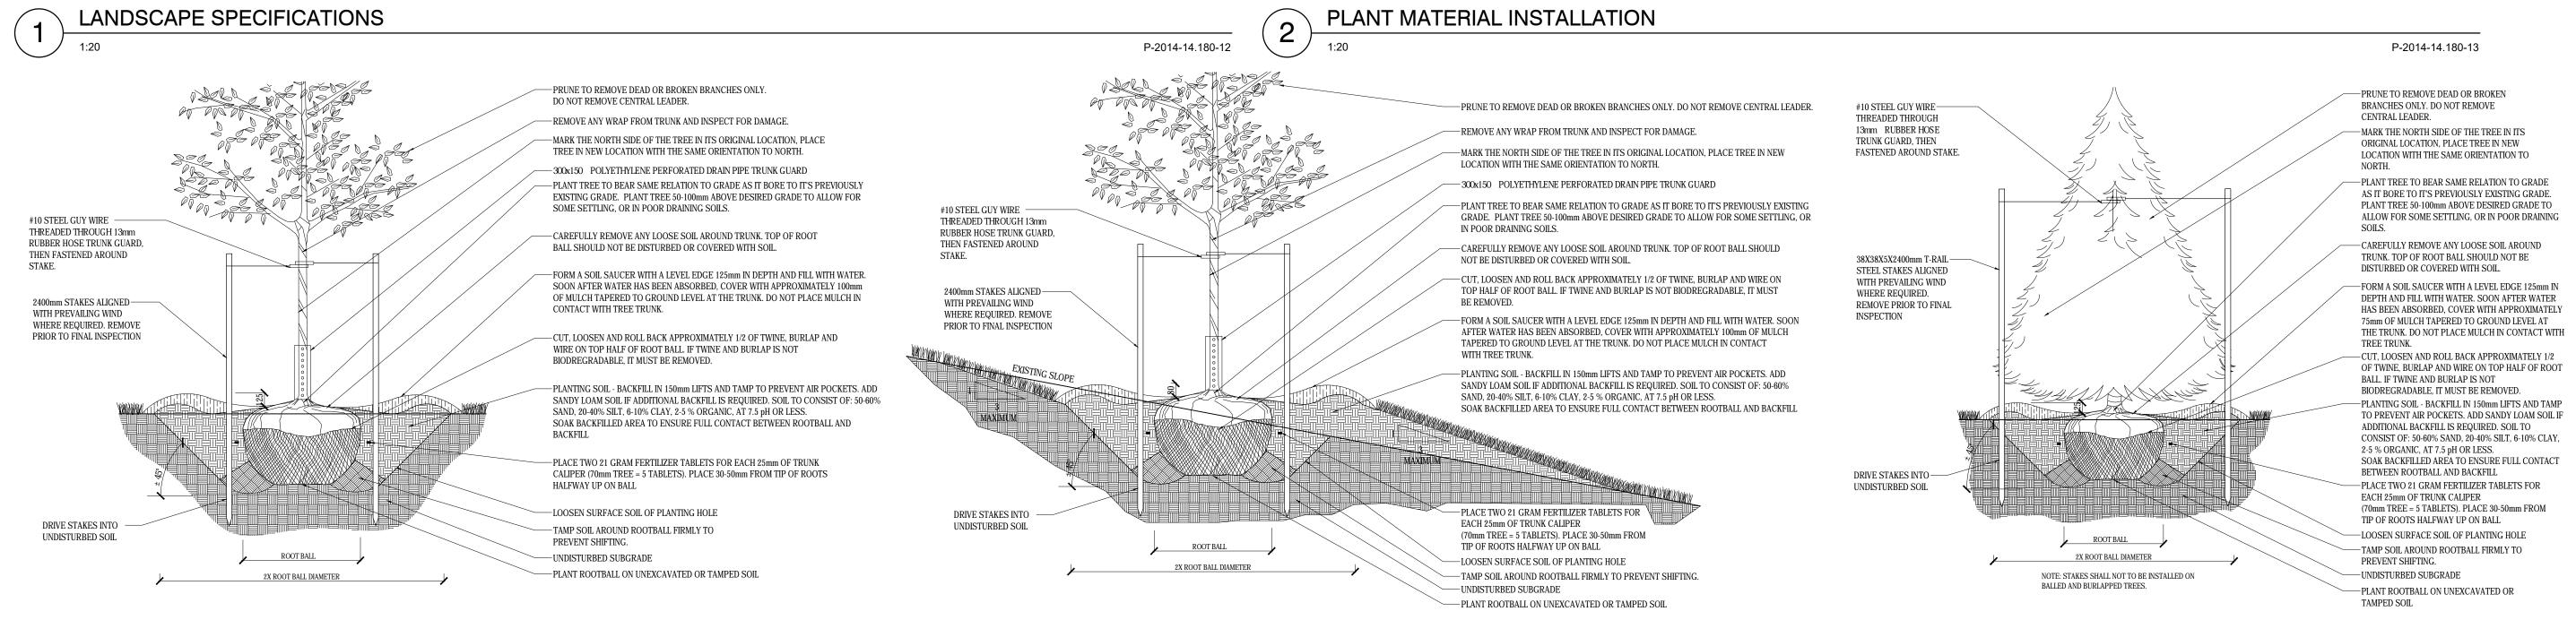

TAKED B&B TREE SLOPED INSTALLATION DETAIL-OV SLAB


STAKED B&B DECIDUOUS TREE INSTALLATION DETAIL

PRUNE TO REMOVE DEAD OR BROKEN BRANCHES #10 STEEL GUY WIRE -ONLY, DO NOT REMOVE CENTRAL LEADER. THREADED THROUGH 13mm RUBBER HOSE -MARK THE NORTH SIDE OF THE TREE IN ITS ORIGINAL TRUNK GUARD, THEN LOCATION, PLACE TREE IN NEW LOCATION WITH THE FASTENED AROUND STAKE. SAME ORIENTATION TO NORTH. -PLANT TREE TO BEAR SAME RELATION TO GRADE AS IT BORE TO IT'S PREVIOUSLY EXISTING GRADE. PLANT TREE 50-100mm ABOVE DESIRED GRADE TO ALLOW FOR SOME SETTLING, OR IN POOR DRAINING SOILS. CAREFULLY REMOVE ANY LOOSE SOIL AROUND TRUNK. TOP OF ROOT BALL SHOULD NOT BE DISTURBED OR COVERED WITH SOIL. 38X38X5X2400mm T-RAIL-FORM A SOIL SAUCER WITH A LEVEL EDGE 125mm IN DEPTH STEEL STAKES ALIGNED AND FILL WITH WATER, SOON AFTER WATER HAS BEEN WITH PREVAILING WIND ABSORBED, COVER WITH APPROXIMATELY 75mm OF MULCH WHERE REQUIRED. TAPERED TO GROUND LEVEL AT THE TRUNK. DO NOT PLACE REMOVE PRIOR TO FINAL MULCH IN CONTACT WITH TREE TRUNK. INSPECTION -CUT, LOOSEN AND ROLL BACK APPROXIMATELY 1/2 OF TWINE, BURLAP AND WIRE ON TOP HALF OF ROOT BALL, IF TWINE AND BURLAP IS NOT BIODREGRADABLE, IT MUST BE REMOVED. -PLANTING SOIL - BACKFILL IN 150mm LIFTS AND TAMP TO PREVENT AIR POCKETS. ADD SANDY LOAM SOIL IF ADDITIONAL BACKFILL IS REQUIRED. SOIL TO CONSIST OF: 50-60% SAND. 20-40% SILT, 6-10% CLAY, 2-5 % ORGANIC, AT 7.5 pH OR LESS. SOAK BACKFILLED AREA TO ENSURE FULL CONTACT BETWEEN ROOTBALL AND BACKFILL UNDISTURBED SOIL PLACE TWO 21 GRAM FERTILIZER TABLETS FOR EACH 25mm OF TRUNK CALIPER (70mm TREE = 5 TABLETS), PLACE ROOT BALL 30-50mm FROM TIP OF ROOTS HALFWAY UP ON BALL -LOOSEN SURFACE SOIL OF PLANTING HOLE 2X ROOT BALL DIAMETER TAMP SOIL AROUND ROOTBALL FIRMLY TO PREVENT NOTE: STAKES SHALL NOT TO BE INSTALLED ON BALLED AND BURLAPPED TREES

STAKED B&B CONIFEROUS TREE SLOPED PLANTING DETAIL SCALE=NO SCALE

-UNDISTURBED SUBGRADE

-PLANT ROOTBALL ON UNEXCAVATED OR TAMPED SOIL

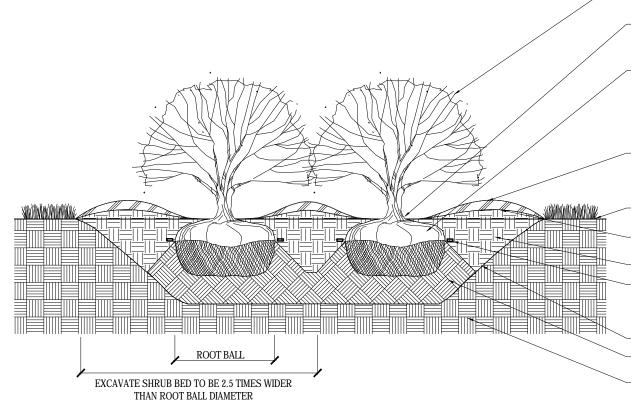

B&B SHRUB BED PLANTING DETAIL

SCALE=NO SCALE

SCALE=NO SCALE

LANDSCAPE ARCHITECT) -CROWN OF ROOT BALL FLUSH WITH FINISH GRADE LEAVING TRUNK FLARE VISIBLE AT THE TOP OF THE ROOT BALL -REMOVE ALL TWINE, ROPE, WIRE, BURLAP AND PLASTIC WRAP FROM TOP HALF OF ROOT BALL (IF PLANT IS SHIPPED WITH A WIRE BASKET AROUND THE ROOT BALL, CUT WIRE IN FOUR PLACES AND FOLD DOWN 200mm INTO

PLANTING HOLE)

-FINISH GRADE

-SHRUB (DO NOT PRUNE, STAKE, OR WRAP

SHRUBS UNLESS DIRECTED TO DO SO BY

70mm DEPTH AFTER SETTLEMENT, MULCH LAYER TO EDGE OF PLANTING BED. DO NOT PLACE MULCH IN CONTACT WITH SHRUB

-100mm HIGH SOIL SAUCER BEYOND EDGE OF ROOT BALL

-PLANTING MIXTURE BACKFILL TWO 21 GRAM FERTILIZER TABLETS FOR EACH SHRUB (DISTRIBUTE TABLETS EQUALLY AMONG SHRUBS IN BED). PLACE 30-50mm FROM EDGE OF ROOTS HALFWAY UP ON BALL -ROUGHEN EDGES OF PLANTING PIT TAMPED PLANTING MIXTURE AROUND BASE OF ROOT BALL -UNEXCAVATED OR EXISTING SOIL

B&B SHRUB SLOPED BED PLANTING DETAIL

EXCAVATE SHRUB BED TO BE 2.5 TIMES WIDER

THAN ROOT BALL DIAMETER

SCALE=NO SCALE

SCALE=NO SCALE



NOT FOR CONSTRUCTION

ISSUED FOR SITE PLAN AMENDMENT 2017-11-16 CR REVISED PER TOWN COMMENTS 2015-04-30 JD 2015-03-17 JD REVISED PER TOWN COMMENTS REVISED PER TOWN COMMENTS 2015-02-19 JD FOR TOWN REVIEW 2014-09-03 JD date CONTRACTOR MUST VERIFY ALL DIMENSIONS ON THE JOB AND REPORT ANY DISCREPANCY TO THE LANDSCAPE ARCHITECT BEFORE PROCEEDING WITH THE ALL DRAWINGS AND SPECIFICATIONS ARE INSTRUMENTS OF SERVICE AND THE PROPERTY OF THE LANDSCAPE ARCHITECT WHICH MUST BE RETURNED AT THE COMPLETION OF THE WORK.

ALL DRAWINGS TO BE USED FOR CONSTRUCTION ONLY WHEN SIGNED BY THE LANDSCAPE ARCHITECT.

Email:terraplan@terraplan.ca Web:www.terraplan.ca PROPOSED COMMERCIAL DEVELOPMENT 135 QUEEN STREET

NIAGARA ON THE LAKE ONTARIO LANDSCAPE DETAILS

CHECKED: NTS

SEPT 2014 PROJECT NO.: 14-180


April 30, 2015

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Canada Tel:(416)638-4911

Fax:(416)638-4261

NOT FOR CONSTRUCTION

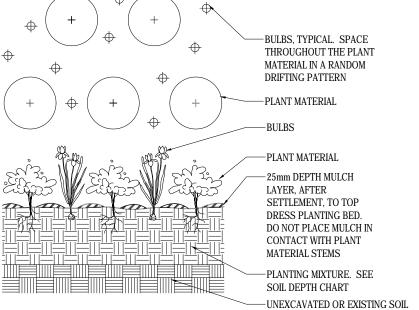

-FINISH GRADE ORNAMENTAL GRASS / PERENNIALS / GROUNDCOVER - TURN BEST SIDE TOWARD MOST PROMINENT VIEW -25mm DEPTH MULCH LAYER, AFTER SETTLEMENT, TO TOP DRESS PLANTING BED. DO NOT PLACE MULCH IN CONTACT WITH PLANT MATERIAL STEMS -RAISE FINISH GRADE OF PLANTING BED 50mm FOR ADEQUATE DRAINAGE --- REMOVE PLANT FROM POT - SLIGHTLY LOOSEN OR SEPERATE IF ROOT MASS IS COMPACTED. PLANT AT

SEEDING AND HYDROSEEDING SPECIFICATIONS AREAS TO BE SEEDED OR HYDROSEEDED SHALL RECEIVE AN APPLICATION OF SEED AT THE RATE AS SPECIFIED ON THE SEED MIXTURE DETAILS.

FERTILIZER SHALL BE COMBINED WITH HYDROSEED MIX AT THE FOLLOWING RATE: RATE PER HECTRE:

5-20-20 ANALYSIS 32-0-0 ANALYSIS (SULPHUR COATED AREA) 0-46-0 ANALYSIS

HYDRAULIC MULCH TO BE APPROVED BY THE LANDSCAPE ARCHITECT SHALL BE APPLIED AT THE RATE OF 2100KG PER HECTARE. TO BE APPLIED BY HAND HELD HOSING AND WALKING THE SITE FOR CONSISTENCY, IN ALL APPLICATIONS AFTER PLANT INSTALLATION. THE CONTRACTOR SHALL NOT CARRY OUT THE WORK UNDER ADVERSE WEATHER CONDITIONS SUCH AS HIGH WIND, FROZEN GROUND OR GROUND COVERED WITH SNOW, ICE OR STANDING

A SOIL TEST SHOULD BE PERFORMED BY A COMPETENT HYDROSEEDING CONTRACTOR TO VERIFY MIXTURE AND PERCENTAGES REQUIRED.

PREPARATION:

GRADE SUB-GRADE, ELIMINATE UNEVEN AREAS AND LOW SPOTS, ENSURE POSITIVE DRAINAGE. REMOVE DEBRIS, ROOTS, BRANCHES, STONES IN EXCESS OF 50MM DIAMETER AND OTHER DELETERIOUS MATERIALS. REMOVE SUBSOIL THAT HAS BEEN CONTAMINATED WITH OIL, GASOLINE OR CALCIUM CHLORIDE, DISPOSE OF REMOVED MATERIAL AS DIRECTED BY LANDSCAPE ARCHITECTS.

GRADE SUB-GRADE FOR HYDRO-SEEDING TO A UNIFORM SURFACE AND REMOVE VEGETATION WHICH MAY INTERFERE WITH SEEDING OPERATIONS. LOOSEN SOIL TO DEPTH OF 25MM MINIMUM AND REMOVE STONES AND FOREIGN MATERIAL WHICH PROTRUDE MORE

THAN 75MM ABOVE THE SURFACE. ENSURE OPTIMUM SOIL MOISTURE CONTENT FOR SEED GROWTH PRIOR TO SCARIFICATION AND SEEDING. USE "SOIL GUARD" BONDED FIBRE MATRIX BY WEHERHAEUSER OR


ALL AREAS TO BE HYDROSEEDED TO RECEIVE 300mm OF TOPSOIL.

SIMILAR APPROVED SOIL STABILIZER FOR ALL SLOPE CONDITIONS.

SEEDED AREAS TO BE MAINTAINED BY CONTRACTOR ENSURING ADEQUATE WATER, FERTILIZER, MAINTENANCE AND REPAIR UNTIL SEEDED AREAS ARE PROPERLY ESTABLISHED. AREAS SEEDED IN FALL WILL BE ACCEPTED IN FOLLOWING SPRING, ONE MONTH AFTER START OF GROWING SEASON PROVIDED ACCEPTANCE CONDITIONS ARE FULFILLED.

MAINTENANCE:

NOTE: SEED MIX AND RATE IS SUBJECT TO CHANGE. LANDSCAPE ARCHITECT TO CONFIRM TIMING, EXISTING CONDITIONS, AND SEED MIXES WITH THE TOWN OF NIAGARA-ON-THE-LAKE PARKS DIVISION IN WRITING PRIOR TO SEEDING OPERATIONS.

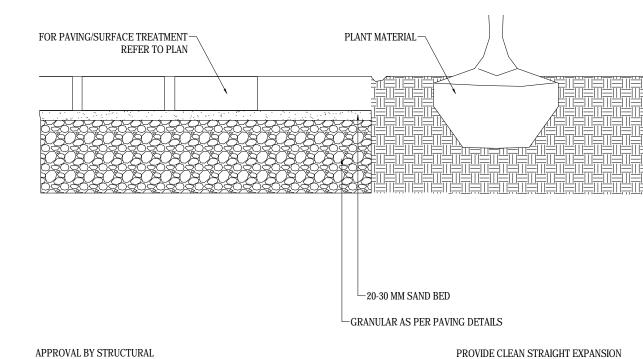

NOTE: AT ALL DRIVEWAYS, SIDEWALK SHALL BE 180MM THICK AND SLOPED TO ACCOMMODATE CURB CUTS CSW-D10

EXPANSION JOINTS AT 6.0M MAXIMUM INT. CONTRACTION JOINTS 3.0M MAX. INT. CSW2SEC.

JOINT BETWEEN EXISTING AND NEW CONCRETE

PAVING OR EXISTING STRUCTURE.

SEEDING AND HYDROSEEDING SPECIFICATIONS

P-2014-14.180-19

PLANTING NEXT TO PAVED AREA SCALE=1:1

BULB PLANTING DETAIL SCALE=NO SCALE

GROUND COVER PLANTING

P-2014-14.180-14

SAME RELATIVE ELEVATION AS ORIGINAL GRADE

—UNEXCAVATED OR EXISTING SOIL

TAMPED PLANTING MIXTURE. SEE SOIL DEPTH CHART

05 ISSUED FOR SITE PLAN AMENDMENT 2017-11-16 CR 04 REVISED PER TOWN COMMENTS 2015-04-30 JD 2015-03-17 JD REVISED PER TOWN COMMENTS 03 2015-02-19 JD 02 REVISED PER TOWN COMMENTS 2014-09-03 JD 01 FOR TOWN REVIEW date by CONTRACTOR MUST VERIFY ALL DIMENSIONS ON THE JOB AND REPORT ANY DISCREPANCY TO THE LANDSCAPE ARCHITECT BEFORE PROCEEDING WITH THE ALL DRAWINGS AND SPECIFICATIONS ARE INSTRUMENTS OF SERVICE AND THE PROPERTY OF THE LANDSCAPE ARCHITECT WHICH MUST BE RETURNED AT THE COMPLETION OF THE WORK. ALL DRAWINGS TO BE USED FOR CONSTRUCTION ONLY WHEN SIGNED BY THE LANDSCAPE ARCHITECT.



Web:www.terraplan.ca Email:terraplan@terraplan.ca


PROPOSED COMMERCIAL DEVELOPMENT 135 QUEEN STREET NIAGARA ON THE LAKE


ONTARIO PROJECT LANDSCAPE DETAILS


SEPT 2014 PROJECT NO.: 14-180

April 30, 2015

20 Champlain Blvd., Suite 102

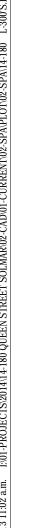

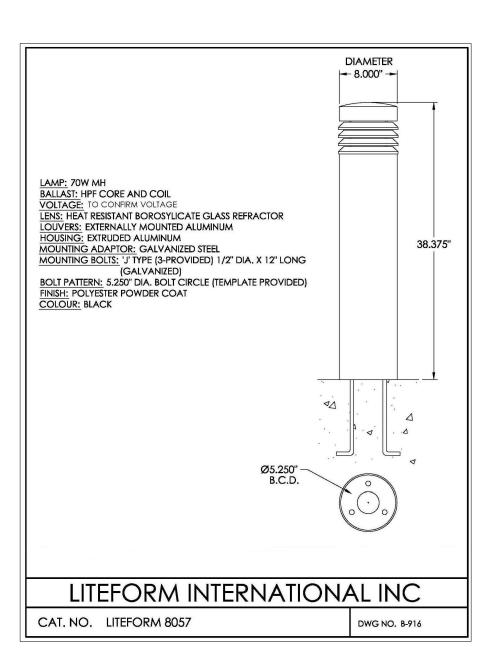

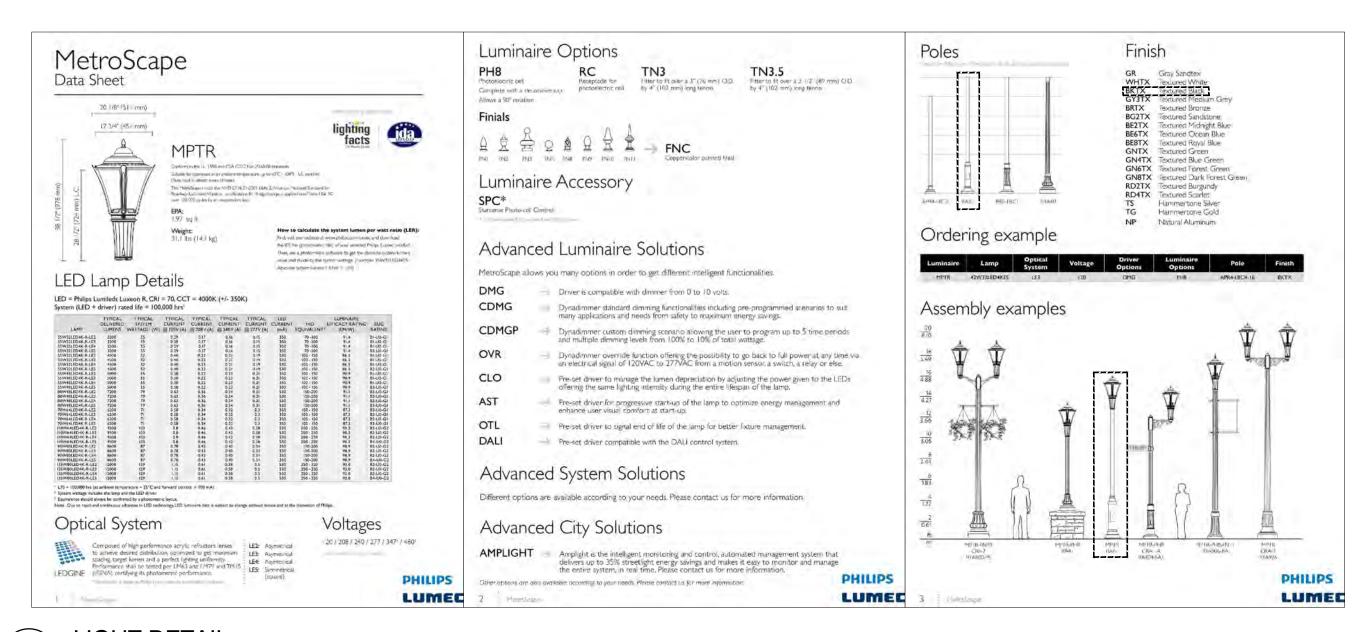

1 LIGHT BOLLARD

1:20 P-2014-14.180-29

2 LIGHT DETAIL


SCALE=1:1

SOLMAR®

Appendix A

CLIE

NOT FOR CONSTRUCTION

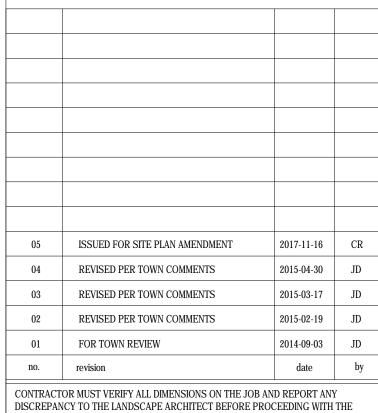

WORK.
ALL DRAWINGS AND SPECIFICATIONS ARE INSTRUMENTS OF SERVICE AND THE PROPERTY OF THE LANDSCAPE ARCHITECT WHICH MUST BE RETURNED AT THE COMPLETION OF THE WORK.
ALL DRAWINGS TO BE USED FOR CONSTRUCTION ONLY WHEN SIGNED BY THE LANDSCAPE ARCHITECT.

signed



Email:terraplan@terraplan.ca Web:www.terraplan.ca

PROPOSED COMMERCIAL DEVELOPMENT
135 QUEEN STREET

135 QUEEN STREET
NIAGARA ON THE LAKE
ONTARIO

LANDSCAPE DETAILS

DRAWN: JD

CHECKED: JD

SCALE: NTS

DATE: SEPT 2014

PROJECT NO.: 14-180

L-303

April 30, 2015

NOT FOR CONSTRUCTION

MATERIAL	LEVEL 1	DESCRIPTION	Bench	
DATE Febuary 27, 2002	UNITS: Inches	Pre	esentatio	n
		M	LB450W	
113 Winnet Steet Woodstock, Ontario Canada N4S 528		SIZE DWG. NO.		REV. A
Telephone: 519 539-6776 Toll Fr Fax: 877-260-9393 F-Mail: sales@modia.com Internet:		SCALE 1:18 CAD F:	ILE: 50-WAAD web CAD	1 DF 1

MATERIALS: Bench frame and seat is made from H.S. steel and flat bar. The back is constructed using lasered steel panels or H.S. steel.

FINISH: All steel components are protected with E-Coat rust proofing. The Maglin Powdercoat System provides a durable finish on all metal

INSTALLATION: The bench is delivered pre-assembled. Holes (0.5") are provided each foot for securing to

TO SPECIFY: Select MLB400M - Style of Back (Laser cut design or H.S. steel) - Powdercoat Color OPTIONS: - Personalization

- Custom Laser Designs COMPLIMENTARY PRODUCTS: - MLWR400-20M - MLP400M MLB400M

STYLE - GRASS

COLOUR FINISH - BLACK

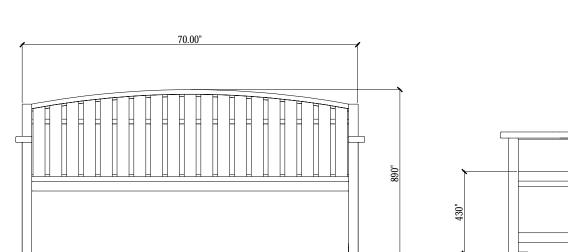




IMAGE OF FENCE TAKEN FROM 156 QUEEN STREET, NIAGARA ON THE LAKE

NOTE: STAIN TO BE SELECTED BY LANDSCAPE ARCHITECT PRIOR TO COMPLETION. SAMPLE TO BE PROVIDED FOR APPROVAL

WOODEN PICKET FENCE 1070 MM HEIGHT

-150mm x 150mm POST TYP.

-38mm x 140mm FRONT FACE

-50mm x 150mm TOP CAP TYP. -50mm x 150mm TOP RAIL TYP.

−50mm x 150mm MID RAIL TYP. -19mm x 140mm VERTICAL TYP.

−38mm x 140mm FRONT FACE TYP. 38mm x 140 mm BACK FACE TYP.

—50mm x 150mm BOTTOM RAIL TYP.

SECURE ALL LUMBER WITH 51 (2")

USE CCA APP. PRESSURE

LONG GALV. TWIST NAILS. ALL DIMENSIONS IN mm. ALL EXPOSED WOOD TO BE COVERED WITH TWO COATS OF

TREATED JACK PINE.

APPROVED STAIN.

∕25mm x 25mm LATTICE

WITH 5MM GAP.

-SUPPORT BRACKETS 75 x 75 x 25; 6 mm THICK HOT DIPPED GALVANIZED SINGLE BRACKETS

-SUPPORT BRACKETS 75 x 75 x 25; 6 mm THICK

SINGLE BRACKETS

HOT DIPPED GALVANIZED

MAGLIN MLWR 400W TRASH RECEPTACLE

P-2014-14.180-30

BENCH DETAIL MAGLIN OR APPROVED EQUAL

P-2014-14.180-21

2400 MAX.

CONCRETE

FOOTING 25MPa IN

28 DAYS TO CSA

MIN STANDARDS

450


150mm x 150mm POST RAISED

EASED POST POST

38mm x 150mm CAP

P-2014-14.180-27

19.250" CONCRETE PAD OR SIDEWALK BIKE RACK, 500, STEEL UNIT EXTENDS 18" PART NO: MBR500-S NOTE: BIKE RACK TO BE DIRECT BURIAL

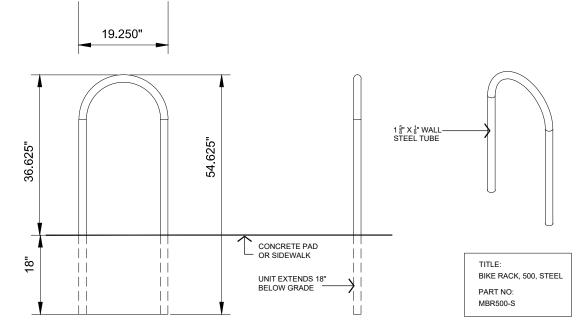



INTO CONCRETE PAD AS SHOWN

1800 MM (6`-0") WOOD FENCE WITH LATTICE

SECTION B-B

100mm MAX.-

─50mm x 150mm MID RAIL TYP.

-50mm x 150mm TOP CAP TYP.

─150mm x 150mm POST TYP.

SECTION A-A

ELEVATION NOTE: STAIN TO BE SELECTED BY LANDSCAPE ARCHITECT PRIOR TO COMPLETION. SAMPLE TO BE PROVIDED FOR APPROVAL

P-2014-14.180-25

ISSUED FOR SITE PLAN AMENDMENT 2017-11-16 CR REVISED PER TOWN COMMENTS 2015-04-30 JD 2015-03-17 JD REVISED PER TOWN COMMENTS 2015-02-19 JD REVISED PER TOWN COMMENTS FOR TOWN REVIEW 2014-09-03 JD date by CONTRACTOR MUST VERIFY ALL DIMENSIONS ON THE JOB AND REPORT ANY DISCREPANCY TO THE LANDSCAPE ARCHITECT BEFORE PROCEEDING WITH THE

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20 Champlain Blvd., Suite 102 terraplan
LANDSCAPE PARCHITECTS

Toronto, Ontario, M3H 2Z1,
Canada Tel:(416)638-4911
Fax:(416)638-4261 Email:terraplan@terraplan.ca

PROPOSED COMMERCIAL DEVELOPMENT 135 QUEEN STREET NIAGARA ON THE LAKE ONTARIO


LANDSCAPE DETAILS

CHECKED: NTS SEPT 2014 PROJECT NO.: 14-180

Web:www.terraplan.ca

April 30, 2015



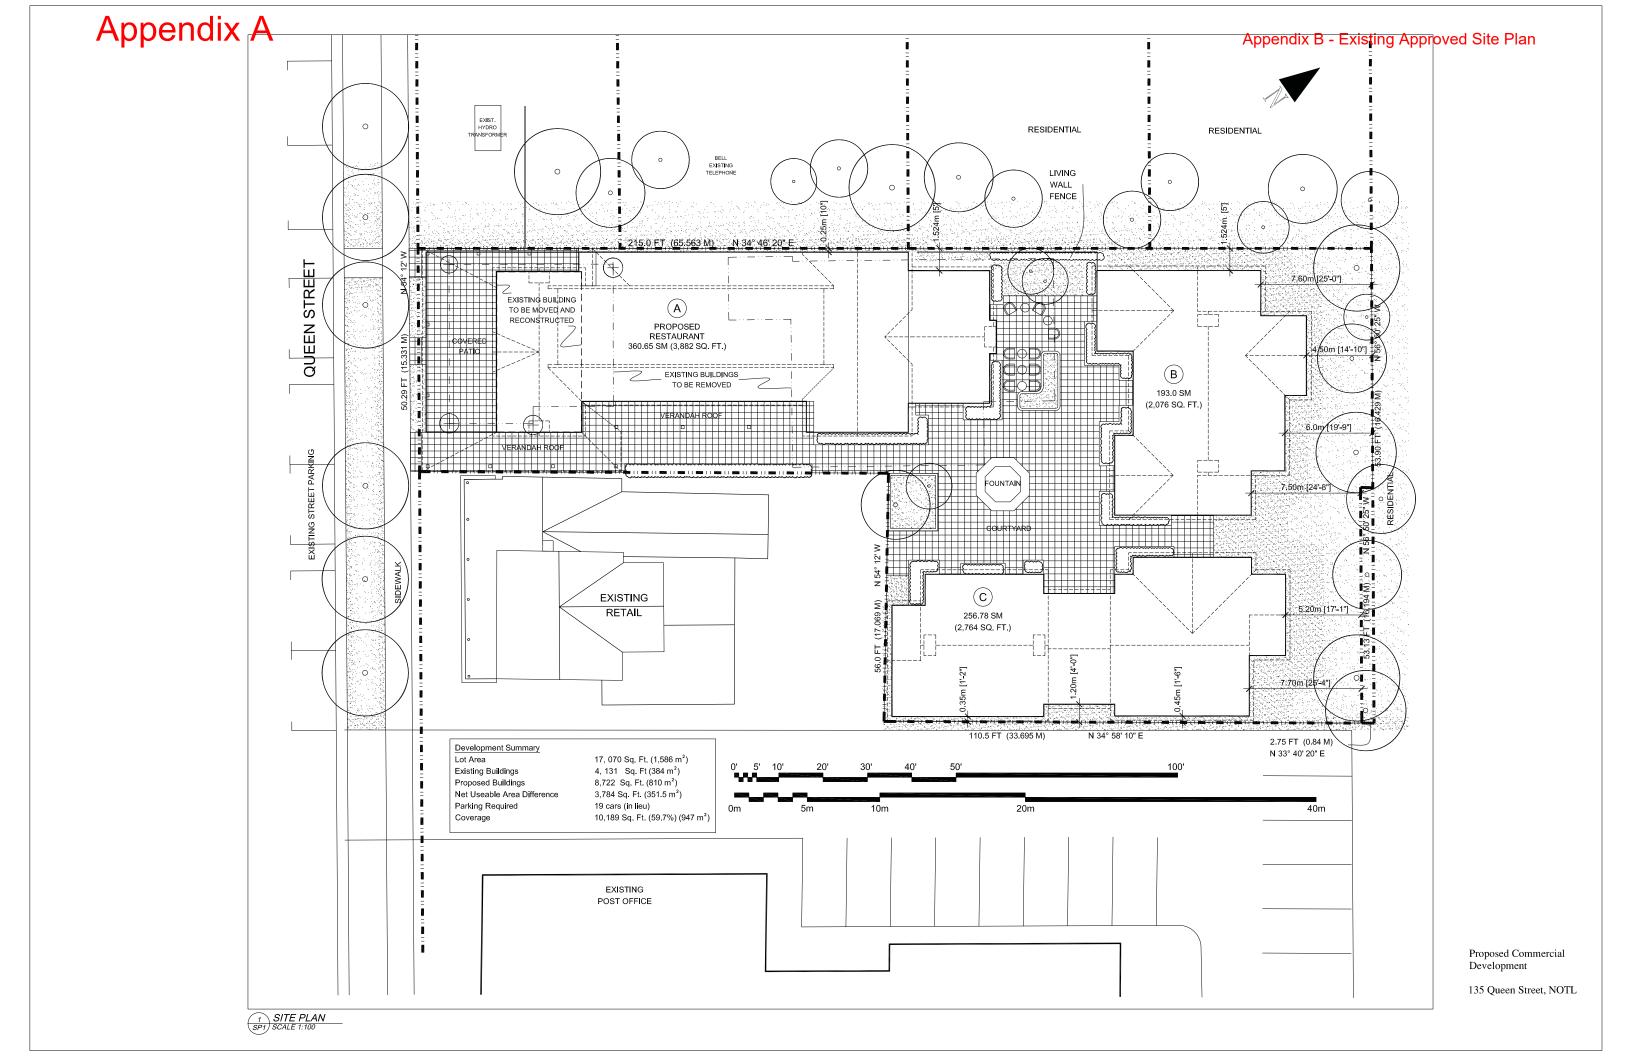

SHOWN AS A WHOLE NUMBER. ALL DIMENSIONS ARE GIVEN TO FACE OF CURB AND FACE OF FOUNDATION AND SITE WALLS, UNLESS OTHERWISE INDICATED. 2. CONTRACTOR SHALL OBTAIN ALL NECESSARY PROVINCIAL OR LOCAL MUNICIPAL PERMITS REQUIRED. ALL CONSTRUCTION SHALL CONFORM

TO PROVINCIAL AND LOCAL MUNICIPAL STANDARDS AND CODES THAT PERTAIN TO THE SITE UNDER CONSTRUCTION.
3. CONTRACTOR SHALL ARRANGE FOR UTILITY STAKING PRIOR TO

START OF CONSTRUCTION. IT IS THE CONTRACTORS RESPONSIBILITY TO VISIT THE SITE PRIOR TO CONSTRUCTION TO BECOME FAMILIAR WITH EXISTING CONDITIONS, IF ANY DISCREPANCIES EXIST BETWEEN THE DRAWINGS AND ACTUAL SITE CONDITIONS, CONTRACTOR SHALL BRING THIS TO THE ATTENTION OF THE LANDSCAPE ARCHITECT.

4 EXISTING UNDERGROUND UTILITIES SHOWN ON THE DRAWINGS ARE PLOTTED FROM ORIGINAL SITE DRAWINGS AND/OR SITE TOPOGRAPHIC SURVEY, EVERY ATTEMPT HAS BEEN MADE TO SHOW ALL UTILITY LINES WHERE THEY EXIST. CONTRACTOR SHALL USE EVERY PRECAUTION IN EXCAVATING SINCE ACTUAL UNDERGROUND UTILITIES MAY NOT BE AS SHOWN CONTRACTOR SHALL MAKE HIMSELF THOROUGHLY FAMILIAR WITH ALL UNDERGROUND UTILITY LOCATIONS PRIOR TO ANY EXCAVATION AND VERIFY LOCATIONS AND DEPTHS OF ALL UTILITIES. CONTRACTOR SHALL PROVIDE HIS OWN LAYOUT, GRADING, STAKING. AND SURVEYING REQUIRED FOR CONSTRUCTION, REFER TO EXISTING SURVEY FOR BENCHMARKS AND OTHER EXISTING INFORMATION. CONTRACTOR SHALL FIELD VERIEY LAYOUT PRIOR TO CONSTRUCTION.

6. CONTRACTOR SHALL PROTECT ALL EXISTING AND NEW CONSTRUCTION FROM DAMAGE, SHOULD ANY DAMAGE OCCUR. CONTRACTOR SHALL MAKE ALL NECESSARY REPAIRS AT NO COST TO THE OWNER.

STREE

QUEEN

7. CONTRACTOR SHALL COORDINATE HIS WORK WITH OTHER CONTRACTORS ON SITE.

8. PROVIDE BARRIERS OR OTHER PROTECTION TO KEEP VEHICULAR AND PEDESTRIAN TRAFFIC AWAY FROM CONSTRUCTION AREA AND OFF NEWLY PAVED AREAS BEFORE ASPHALT OR CONCRETE HAS CURED. DO

NOT LEAVE ANY HOLES OPEN OVERNIGHT.

9. KEEP AREA OUTSIDE CONSTRUCTION ZONE CLEAN AND USABLE BY OTHERS AT ALL TIMES.

10. CONTRACTOR SHALL SUBMIT SAMPLES OF ALL PROPOSED

MATERIALS FOR APPROVAL PRIOR TO PLACING ORDERS. 11. ALL WORK SHALL BE INSPECTED BY LANDSCAPE ARCHITECT PRIOR TO PAYMENT APPROVAL

12. CONTRACTOR SHALL PROVIDE MARKED-UP REDLINE PLANS SHOWING AS-BUILT SITE CONDITIONS TO THE LANDSCAPE ARCHITECT, PRIOR TO OBTAINING APPROVAL OF SUBSTANTIAL COMPLETION. 13. AT ALL EDGES OF EXISTING SIDEWALK OR CURB AGAINST WHICH NEW CONCRETE IS TO BE PLACED, SAWCUT AND REMOVE EXISTING CONCRETE BACK TO THE NEAREST CONTRACTION JOINT TO PROVIDE A SMOOTH TRANSITION TO THE NEW CONCRETE.

TO BE MOVED ANI

14. INSTALL ISOLATION JOINTS AT ALL LOCATIONS WHERE NEW CONCRETE MEETS EXISTING CONCRETE PAVEMENT

Lot Area

Existing Buildings

Parking Required

Net Useable Area Diffe

LANDSCAPE NOTES

PROPOSED RESTAURANT 360 65 SM (3.882 SQ. FT.)

EXISTING

17, 070 Sq. Ft. (1.586 m²)

4, 131 Sq. Ft (384 m²)

8,722 Sq. Ft. (810 m²)

19 cars (in lieu)

3,784 Sq. Ft. (351.5 m²)

10,189 Sq. Ft. (59.7%) (947 m²)

ALL PLANTING AND INSTALLATION IN RIGHT OF WAY SHALL MEET LOCAL MUNICIPAL STANDARDS AND SPECIFICATIONS.

2 LANDSCAPE CONTRACTOR SHALL COORDINATE HIS WORK WITH OTHER CONTRACTORS ON SITE TO MINIMIZE DAMAGE TO COMPLETED LAWN AND PLANT MATERIAL INSTALLATION. 3. IF ANY DISCREPANCY EXISTS BETWEEN THE QUANTITIES, SIZES OR MATERIALS INDICATED ON THE PLAN AND SHOWN IN THE PLANT LIST,

THE PLAN SHALL GOVERN.

4. IT IS THE LANDSCAPE CONTRACTORS RESPONSIBILITY TO VISIT THE SITE PRIOR TO START OF WORK, TO BECOME FAMILIAR WITH EXISTING

CONDITIONS AT THE SITE.
5. THE EARTHWORK CONTRACTOR IS RESPONSIBLE FOR ROUGH GRADING OF SUBGRADE BELOW LAWN AND LANDSCAPE AREAS. 6. THE LANDSCAPE CONTRACTOR IS RESPONSIBLE FOR RESPREADING TOPSOIL, FINE GRADING AND PREPARATION OF ALL LAWN AND LANDSCAPE AREAS

LANDSCAPE CONTRACTOR SHALL PROVIDE SOIL TEST ANALYSIS FOR ALL SOIL USED ON PROJECT, COPIES OF SOIL ANALYSIS SHALL BE PROVIDED TO LANDSCAPE ARCHITECT PRIOR TO ANY LANDSCAPE CONSTRUCTION.

8. PRIOR TO SPREADING TOPSOIL, LANDSCAPE CONTRACTOR SHALL INSPECT AND ACCEPT ALL BASE GRADES, ANY DEVIATION FROM LINE AND GRADE INDICATED ON THE GRADING PLAN SHALL BE CORRECTED BY EARTHWORK CONTRACTOR BEFORE PLACING ANY TOPSOIL. 9. BEFORE PLANT MATERIAL INSTALLATION BEGINS, STAKE LOCATIONS OF NEW PLANT MATERIAL AND NOTIFY LANDSCAPE ARCHITECT FOR APPROVAL, NOTIFY LANDSCAPE ARCHITECT ONE WEEK MINIMUM PRIOR TO TENTATIVE DATE OF STAKING.

10. CONTRACTOR SHALL NOTIFY LANDSCAPE ARCHITECT IF AREAS OF POOR DRAINAGE OR OTHER UNUSUAL SUBSURFACE CONDITIONS ARE ENCOUNTERED DURING EXCAVATION FOR PLANTING PITS.

11. ALL GRADING, UTILITY, AND IRRIGATION WORK SHALL BE COMPLETED PRIOR TO INSTALLATION OF PLANT MATERIAL AND LANDSCAPE MULCH. 12. ALL PLANT MATERIAL SHALL BE GROWN IN CLAY SOIL, ALL SHRUBS SHALL BE GROWN IN FIBRE POT CONTAINERS. ALL TREES SHALL BE NURSERY GROWN AND TRANSPLANTED USING THE BALL AND BURLAP

METHOD 13. ALL SHRUBS AND CONIFEROUS PLANTINGS SHALL BE INSTALLED IN CONTINUOUS PLANTING BEDS. 14. ALL SHRUB BEDS ADJACENT TO LAWN AREAS SHALL HAVE A SPADED EDGE BORDER. BORDER SHALL BE CUT 80MM DEEP AT A 45° ANGLE, SO THERE IS A CLEAR AND WELL DEFINED SEPARATION BETWEEN THE PLANTING BEDS AND SODDED AREAS.

15. ALL SHRUB BED AREAS SHALL HAVE A MINIMUM 80MM THICK LAYER OF LANDSCAPE MULCH. 16. PRE-EMERGENT HERBICIDE SHALL BE USED UNDER MULCH IN ALL LARGE BED AREAS 17. WHERE PROJECT SITE IS TO BE SODDED, CONTRACTOR SHALL PROVIDE NEW TOPSOIL AND SOD IN ANY ADJACENT RIGHT OF WAY FROM PROPERTY LINE TO BACK OF MUNICIPAL CURB.

18. CONTRACTOR SHALL WORK OVER LAWN AREAS THAT HAVE REMAINED PARTIALLY INTACT, TOP DRESSING WITH SOIL, SCARIFYING, AND SEEDING TO FORM A SMOOTH, FULL, EVEN LAWN, FREE OF BARE SPOTS, INDENTATIONS, AND WEEDS. 19. LANDSCAPE CONTRACTOR SHALL COORDINATE PLANTING SCHEDULE WITH IRRIGATION CONTRACTOR TO ENSURE PROPER WATERING OF PLANTED AND SEEDED AREAS AFTER INSTALLATION, LANDSCAPE CONTRACTOR SHALL COORDINATE PLANTING WITH IRRIGATION CONTRACTOR TO MINIMIZE CONFLICTS BETWEEN PLANTS AND SPRINKLER HEADS AND LINES. RESIDENTIAL RESIDENTIAL 8-10-04PC 7.60m [25'-0"] 4.50m (14 (B) 6.0m [19'-9"] 7.50m [24'-8"] 5.20m [17'-1"] 7.70m [25'-4"] 2.764 SQ. FT.) 2.75 FT (0.84 M) N 33° 40' 20" E





NOT FOR CONSTRUCTION

DRAWINGS LIST

REVISED PER TOWN COMMENTS REVISED PER TOWN COMMENTS 2015-02-19 JD FOR TOWN REVIEW

CONTRACTOR MUST VERIFY ALL DIMENSIONS ON THE JOB AND REPORT ANY DISCREPANCY TO THE LANDSCAPE ARCHITECT BEFORE PROCEEDING WITH THE NORK. ALL DRAWINGS AND SPECIFICATIONS ARE INSTRUMENTS OF SERVICE AND THE PROPERTY OF THE LANDSCAPE ARCHITECT WHICH MIST BE RETLIBUED AT THE

OMPLETION OF THE WORK, LL DRAWINGS TO BE USED FOR CONSTRUCTION ONLY WHEN SIGNED BY THE



PROPOSED COMMERCIAL DEVELOPMENT 135 QUEEN STREET

NIAGARA ON THE LAKE ONTAR**I**O

LANDSCAPE PLAN - COVER SHEET

CHECKED: JD 1:125 SCALE: SEPT 2014 DATE: PROJECT NO.: 14-180

L-100



40m

bgmt 216 BUXUS X "GREEN MOUNTAIN"

bgv 34 BUXUS X GREEN VELVET

paebb 22 PAEONIA X BOWL OF BEAUTY

BOXWOOD

BOXWOOD

BOWL OF BEAUTY PEONY

gcb 119 GERANIUM CINEREUM 'BALLERINA' BALLERINA HARDY GERANIUM FLAT - 9CM POT haa 164 HYDRANGEA ARBORESCENS 'ANNABELLE' ANNABELLE SMOOTH HYDRANGEA CONT,

hmb 35 HYDRANGEA MACROPHYLLA 'BAILMER' TM ENDLESS SUMMER

60 CM 0.50m

Appendix B - Existing Approved Sit

NOT FOR CONSTRUCTION

	EXIST. HYDRO	
	TRANSFORMER RESIDENTIAL RESIDENTIAL RESIDENTIAL	
	ENSTING TELEPHONE ARP	
allm III	215.0 FT (65.563 M) N 34° 46′ 20″ E 0 1 1 1 1 1 1 1 1 1 1 1 1 1 1 1 1 1 1	
haal 10 bgmt 22 bgmt 11	500 SOD 7.60m [25-0"]	
TRE	Existing Bull Ding	
'S ///	TO BE MOVED AND RECONSTRUCTED PROPOSED 12 13 13 13 15 15 15 15 15 15 15 15 15 15 15 15 15	
E	COVERED 360.65 SM (3,882 SQ. FT.) RESTAURANT 360.65 SM (3,882 SQ. FT.)	
O Imw	EXISTING BUILDINGS TO BE REMOVED TO BE REMOVED TO BE REMOVED TO BE REMOVED	
haa 24	193.0 SM 193.0 SM (2076 SO FT)	
EXISTING LIGHT TO REMAIN— Dogmt D	VERANDAH ROOF VERANDAH ROOF 1.	
5	VERANDAH ROOF VERANDAH ROOF OF THE PROPERTY	
T PAR	Depth Dept	
STREE	SOD	
	SOD COURTYARD	CON
		DISI WO ALL PRO COI
	EXISTING EXISTING	ALL
	RETAIL 7 11 6 520m [17:-1"] 5.20m [1	s = = = = = = = = = = = = = = = = = = =
		1
	- L 256.78 SM E 7.70m [25:44]	
	10 F T 12 C C F M N 24 F P 10 F	PRO PL
	Development Summary	DRAV DRAV
	Existing Buildings 4, 131 Sq. Ft (384 m²) Proposed Buildings 8,722 Sq. Ft. (810 m²) Proposed Buildings 8,722 Sq. Ft. (810 m²)	CHEC SCAL DATE
	Net Useable Area Difference 3,784 Sq. Ft. (351.5 m²) Parking Required 19 cars (in lieu) 0m 5m 10m 20m 40m	PROJ

03	REVISED PER TOWN COMMENTS	2015-03-17	JD			
02	REVISED PER TOWN COMMENTS	2015-02-19	JD			
01	FOR TOWN REVIEW	2014-09-03	JD			
no.	revision	date	by			
CONTRACTOR MILET VERIEV ALL DIMENSIONS ON THE IOR AND REPORT ANY						

CTOR MUST VERIFY ALL DIMENSIONS ON THE JOB AND REPORT ANY PANCY TO THE LANDSCAPE ARCHITECT BEFORE PROCEEDING WITH THE IY OF THE LANDSCAPE ARCHITECT WHICH MUST BE RETURNED AT THE TION OF THE WORK, WINGS TO BE USED FOR CONSTRUCTION ONLY WHEN SIGNED BY THE JPE ARCHITECT.

20 Champlain Bhdi, Suite 102 Toronto, Ontaio, MSH 221, Candat Full 418(638-4911 Fax(416)638-4261

terraplan@terraplan.ca

ROPOSED COMMERCIAL DEVELOPMENT
135 QUEEN STREET NIAGARA ON THE LAKE ONTAR**I**O


NTING PLAN


L-101





NOT FOR CONSTRUCTION

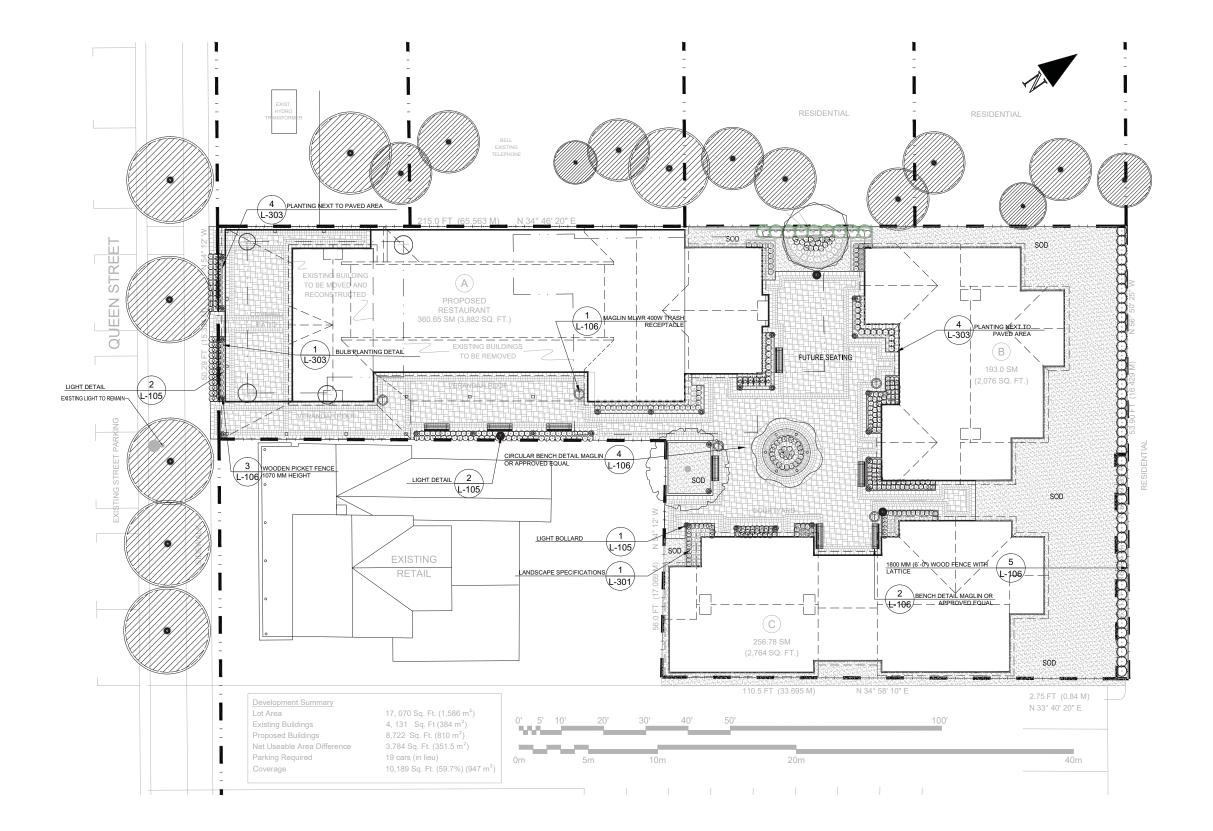

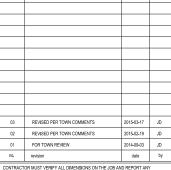

CONTRACTOR MUST VERIFY ALL DIMENSIONS ON THE JOB AND REPORT ANY DISCREPANCY TO THE LANDSCAPE ARCHITECT BEFORE PROCEEDING WITH THE WORK.

20 Champlain Blvd., Suite 102
Toronto, Ontario, MSH 227.
Canada Tel;416)838-4911
Fax;410)838-4261

PROPOSED COMMERCIAL DEVELOPMENT
135 QUEEN STREET

DETAIL REFERENCE PLAN

CHECKED: JD SCALE: 1:125 DATE: SEPT 2014



L-200

CONTRACTOR MUST CONTACT ALL UTILITY COMPANIES FOR STAKE OUTS PRIOR TO ANY EXCAVATION OR PLANTING. ROUGH GRADING

ROUGH GRADE AND FILL AREAS TO ESTABLISH SUBGRADE AS REQUIRED. PROVIDE DRAINAGE PATTERN AS INDICATED ON DRAWNIGS. ROUND SMOOTHLY ALL TOPS AND TOES OF SLOPES. COMPACT ALL AREAS TO 95% STANDARD PROCTOR DENSITY UNLESS SPECIFIED OTHERWISE. EXISTING TREES TO REMAIN ON SITE ARE TO BE PROTECTED AS DETAILED.

FINE GRADING

TINE GRADE ALL AREAS TO FINISHED GRADES AS SHOWN ON LAYOUT OR GRADING PLAN OR ARCHITECT'S SITE PLAN. PROVIDE UNIFORM SLOPES AWAY FROM THE BUILDING, UNLESS SPECIFIED OTHERWISE. SLOPES MAY NOT EXCEED 33 1/3% (3:1).

TOPSOIL FOR SODDED & SEEDED AREAS:
Mixture of mineral particulates, micro organisms and organic matter which provides suitable medium for supporting intended plant

growth. 1 Soil texture based on The Canadian System of Soil Classification, to consist of

- Soil texture based on I file Canadian System of Soil Classification, to consist of 20 to 70% sand and cortain is 10 to 10% organic matter by weight.

 1 Nirogen (N): 20 to 40 micrograms of available N per gram of topsoil.

 2 Phosphorus (P): 10 to 20 micrograms of phosphase per gram of topsoil.

 3 Postassium (N: 80 to 120 micrograms of phosphase per gram of topsoil.

 4 Calcium, magnesium, sulphur and micro-nutrients present in balanced ratios to
- Support germination and/or establishment of intended vegetation
 Ph value: 5.5 to 7.5.

 Contain no toxic elements or growth inhibiting materials.
- Free from:
 1 Debris and stones over 25 mm diameter.
 2 Course vegetative material, 10 mm diameter and 100 mm length, occupying more.

3

6

2. Course vegetative material, 10 mm diameter and 100 mm length, occupying more than 2½ of 50 in/outne. Consistence: finable when moist. Stocked piled on sile Topsoil must be lested by A&L Canada Laboratories East (519-457-2575), provide results for tests: STP1 and STEXT and a method of amending the soil to Terraplan for approval. All topsoil is the method below psendifications.

SPREADING OF TOPSOIL SCARRY THE SUBSOIL PRIOR TO THE SPREADING THE TOPSOIL. REMOVE ALL DEBRIS AND LEAVE A FINE—TEXTURED EVEN SURFACE. ALL TOPSOIL TO BE IMPORTED UNLESS. PREVIOUSLY APPROVED BY LANDSCAPE ARCHITECT. OBTAIN APPROVAL FOR THE QUALITY OF ANY IMPORTED TOPSOIL BEFORE DELIVERY TO THE SITE.

<u>SOD</u>
USE SOD WHICH CONFORMS WITH THE SPECIFICATIONS OF THE NURSERY SOD GROWERS ASSOCIATION OF ONTARIO. ALL LAWN AREAS SHALL RECEIVE A MINIMUM OF TOOM (4") OF OPPOIL, AND SHALL REC SODDED WITH #I BLUCRASS — FESCUE SOD, NO SOD SLOPES ARE TO EXCEED 3:1. SLOPE IN EXCESS OF 4:1 TO BE PEGGED. 4:1 TO BE PEGGED.

THE CONTRACTOR SHALL BE RESPONSIBLE FOR CUTTING ALL SODDED AND SEEDED AREAS AT LEAST TWO

(2) TIMES BEFORE FINAL INSPECTION FOR ACCEPTANCE OF THE LANDSCAPE WORK.

MINERAL FERTILIZEK
APPLY THE FOLLOWING MINERAL FERTILIZER UNLESS SOILS TESTS SHOW OTHER REQUIREMENTS FOR NITROGEN AND POTASH:

1. SODDED AREAS: INITIAL PLANTING: 20% NITROGEN, 0% PHOSPHORUS AND 15% POTASH (20-0-15) AT THE RATE OF 4.5 KG OVER 100 SQM (10 LBS OVER 1000 SQ. FT.). ON-GOING TURF MAINTEMANCE, APPLY 16-0-8 (SUMMER AND FALL) APPLY AFTER THE 8th WEEK.

2. PLANTING BEDS - 7% NITROGEN, 7% PHOSPHORUS AND 7% POTASH (7-7-7) AT THE RATE OF 40 GRAMS (4 0Z.) FOR EVERY BUSHEL OF TOPSOIL.

PREPARATION OF PLANTING BEDS

ALL PLANT BEDS TO BE CONTINUOUS.

EXCAVITE ALL PLANTING BEDS TO THE DEPTH AS INDICATED ON THE DRAWINGS AND DETAILS, MIN 600mm (2.0°). BACK FILL ALL PLANTING BEDS WITH A SOIL MIXTURE CONSISTING OF SIX (6) PARTS OF SAND LOAM, ONE (1) PARTS OF INTELLY PULVERIZED PEAT MOSS, YMO (2) PARTS OF WELL-ROTTED MANURE AND THE MINERAL FERTILIZER AS SPECIFIED ABOVE. ALSO ADD .58 KILOS BONEMEAL/CUBIC METER OF PLANTING SOIL (1 LE_/CUBIC YARD). PREPARE THE PLANTING BEDS FOR PLANTING BEFORE THE DELIVERY RETERMENT OF PLANTING BEDS FOR PLANTING BEFORE THE DELIVERY RETERMENT OF PLANTING BEDS FOR PLANTING BEDS FOR THAT DELIVERY RETERMENT OF PLANTING BEDS FOR THAT DELIVERY RETERMENT OF PLANTING BEDS FOR THAT DELIVERY RETERMENT OF THE PLANTING BEDS FOR THAT DELIVERY OF APPROVAL AND ACCEPTANCE.

PLANT MATERIALS
ALL PLANT MATERIALS
ALL PLANT MATERIAL
SHALL CONFORM TO THE STANDARDS OF THE LANDSCAPE ONTARIO HORTICULTURAL
TRADES ASSOCIATION (LOHTA) FOR SIZE AND SPECIES.
ALL SHRUB AND TREE MATERIAL SHALL BE CONTAINER GROWN, POTTED, S/B OR B/B, UNLESS OTHERWISE
NOTED. BARE ROOT PLANTING SHALL BE ACCEPTABLE FOR CETAIN SPECIES DURING EARLY SPRING OR
LATE FALL PLANTING SEASON. CONTRACTOR SHALL MAKE REQUESTS FOR ROOT CONDITION SUBSTITUTION
IN WRITING TO THE LANDSCAPE ARCHITECT PRIOR TO COMMENCEMENT OF PLANTING OPERATIONS. ALL
PLANT MATERIAL TO BE CLAY GROWN STOOK UNLESS OTHERWISE NOTED.

SODDED AREAS AND PLANTING BED

CONTRACTOR TO INSTALL NEW SOD AND NEW TOPSOIL AS PER SPECIFICATIONS AND GENERAL NOTES THROUGHOUT THE SITE AS DESIGNED. NEW TOPSOIL AND SOD SHALL EXTEND THROUGH THE MUNICIPAL BOULEVARD TO THE REAR OF THE MUNICIPAL CURB.

ALL PLANTING BEDS THAT ARE SURROUNDED BY SOD SHOULD BE CUT AND EDGED AT A 45' ANGLE, SO THERE IS A CLEAR AND WELL DEFINED SEPARATION BETWEEN THE PLANTING BEDS AND SODDED AREAS.

ALL TREES, SHRUBS AND GROUND COVERS SHALL BE PLANTED AS DETAILED AND AS SHOWN ON THE PLANTING PLAN. ALL BEDS TO RECEIVE A COVER OF CLEAN MULCH TO A DEPTH OF 75mm(3"). FOR GUYING AND STAKING TREES, REFER TO PLANTING DETAILS. WRAP ALL DECODUOUS TREES UNDER EXPERIENCED SUPERVISION ONLY TO THE SPECIFICATIONS OF THE LANDSCAPE ONTARIO HORTICULTURAL TRADES ASSOCIATION (LOHTA).
PLANT MATERIAL SIZES AND CONDITIONS ARE TO BE AS INDICATED ON THE LANDSCAPE DRAWING.

THE INDIVIDUAL PLANT GROUPING TOTAL AS ILLUSTRATED ON THE PLANTING PLAN SUPERSEDES THE ESTIMATED QUANTITY ON THE MASTER PLANT LIST. CONTRACTOR MUST REPORT ANY DISCREPANCIES TO THE LANDSCAPE ARCHITECT IN WRITING BEFORE COMMENCING ANY WORK. CONTRACTOR WILL ASSUME FULL RESPONSIBILITY IF LANDSCAPE ARCHITECT IS NOT NOTIFIED OF DISCREPANCIES.

* MULCH - SHREDDED PINE MULCH BY "GRO BARK" OR APPROVED EQUAL. LANDSCAPE ARCHITECT TO APPROVE MULCH BEFORE INSTALLATION. GENERAL MAINTENANCE

APPROVE MULCH BEFORE INSTALLATION. GENERAL MAINTENANCE

PROPER MAINTENANCE PROCEDURES ARE TO BE FULLY ADMINISTERED FOR ALL NEWLY CONSTRUCTED

LANDSCAPE WORK, IN ACCORDANCE WITH LANDSCAPE ONTAKIO SPECIFICATIONS (SECTION 1E —

MAINTENANCE WORK). THIS SHALL APPLY ONLY DURING THE CONSTRUCTION FERIOD. UNLESS OTHERWSE

SPECIFED. CONTRACTOR IS RESPONSBLE FOR MAINTENANCE OF SOO AND PLANTING UNTIL FINAL

ACCEPTANCE BY LANDSCAPE ARCHITECT

SHALL BE RESPONSBLE FOR THE PROTECTION OF ALL TREES.

WITH STATEMENT OF THE CHARGES SHALL BE RESPONSBLE FOR THE DURATION OF THE CURARNITY

PERIOD. PROTECTIVE GUARDS SHALL BE EMPLOYED AROUND ALL DECIDIOUS TREES. GUARDS TO BE

150MM DIA. PVC IPPE OR AS MUNICIPAL GUIDELINES. GUARDS SHALL BE INSTALLED PRIOR TO THE

APPLICATION OF THE MULCH AND SHOULD BE PLACED A MINIMUM OF 50MM (2") OUT FROM THE TREE

TRUNK ON ALL SIDES.

ALL SHRUBS AND CONFEROUS TREES SHALL HAVE AN APPLICATION OF "SKOOT" OR APPROVED

EQUIVALENT ROCENT FORMULA, TO BE APPLIED AT THE END OF OCTOBER. FOLLOW MANUFACTURER'S

DIRECTIONS FOR APPLICATION.

GENERAL REQUIREMENTS


USE ABOVE SPECIFICATIONS IN CONJUNCTION WITH THE GENERAL LANDSCAPE SPECIFICATIONS OF THE OSE ABOVE SPECIFICATIONS IN CONTOURLING WITH THE GENERAL EARDSCAPE OFFICIALITIES OF THE LANDSCAPE ONTARIO HORTICULTURAL TRADES ASSOCIATION (CHITA) AND THE NURSERY SOD GROWERS ASSOCIATION OF ONTARIO. USE ONLY PLANT MATERIAL TRUE TO NAME, SIZE AND GRADE AS SPECIFIED ON PLANTING PLAN, PROVIDE SUFFICIENT LABELS OR MARKINGS TO INDICATE CLEARLY THE VARIETY, SIZE AND GRADE OF EACH SPECIMEN OR BUNDLE.

OBTAIN APPROVAL FOR SUBSTITUTIONS AS TO VARIETY, SIZE OR GRADE FROM THE LANDSCAPE ARCHITECT. USE ONLY NURSERY STOCK GROWN UNDER PROPER HORTICULTURAL PRACTICES, WABLE, FREE FROM PEST AND DISCASE AND UNDAMAGED. HEEK LOCATIONS AND DEFAIN STAKEOUTS OF ALL UTILITY LINES OF A DEFAIL OF THE PROPERTY OF THE TENDER OF THE PROPERTY OF THE TENDER OF THE PROPERTY OF THE TENDER OF THE PROPERTY OF THE PROPERTY OF THE TENDER OF THE PROPERTY OF THE PROPERTY OF THE TENDER OF THE PROPERTY OF

CHARANTEE PERIOD

Appendix B - Existing Approved Site

NOT FOR CONSTRUCTION

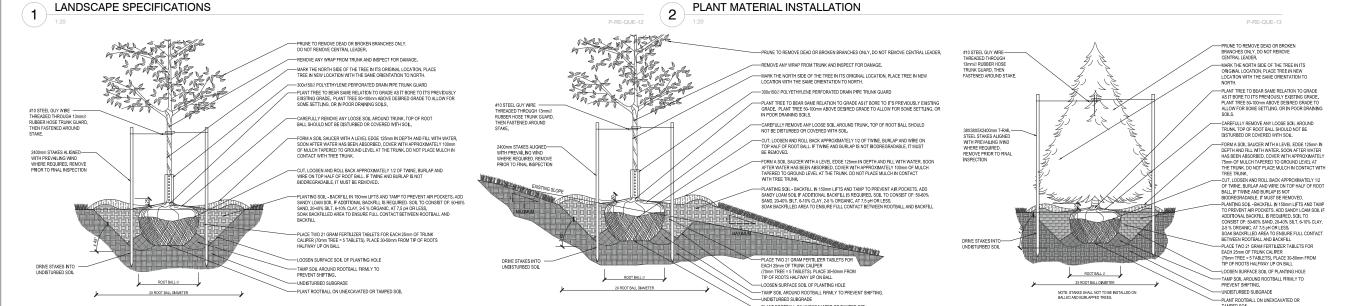

STAKED B&B TREE SLOPED INSTALLATION DETAIL-OV SLAB

STAKED B&B DECIDUOUS TREE INSTALLATION DETAIL

NOTE: STAKES SHALL NOT TO BE INSTALLED ON BALLED AND BURLAPPED TREES.

PRUNE TO REMOVE DEAD OR BROKEN BRANCHES ONLY, DO NOT REMOVE CENTRAL LEADER. ARK THE NORTH SIDE OF THE TREE IN ITS ORIGINAL OCATION, PLACE TREE IN NEW LOCATION WITH THE -PLANT TREE TO BEAR SAME RELATION TO GRADE AS IT BORE TO IT'S PREVIOUSLY EXISTING GRADE. PLANT TREE 50-100mm ABOVE DESIRED GRADE TO ALLOW FOR SOME SETTLING, OR IN POOR DRAINING SOILS. -FORM A SOIL SAUCER WITH A LEVEL EDGE 125mm IN DEPTH AND FILL WITH WATER, SOON AFTER WATER HAS BEEN ABSORBED, COVER WITH APPROXIMATELY 75mm OF MULCH TAPERED TO GROUND LEVEL AT THE TRUNK, DO NOT PLACE MULCH IN CONTACT WITH TREE TRUNK. —CUT, LOOSEN AND ROLL BACK APPROXIMATELY 1/2 OF TWINE BURLAP AND WIRE ON TOP HALF OF ROOT BALL. IF TWINE AND BURLAP IS NOT BIODREGRADABLE, IT MUST BE REMOVED, PLANTING SOIL - BACKFILL IN 150mm LIFTS AND TAMP TO PREVENT ARE POCKETS, ADD SAMPLE OF SHOT JAMP SHOT PREVENT ARE POCKETS, ADD SAMP LOAM SOUL IF ADDITIONAL BACKFILL IS REQUIRED, SOIL TO CONSIST OF: 59-60% SAND, 20-40% SILT, 6-10% CLAY, 2-5 % ORGANIC, AT 7.5 pH OR LESS. SOAK BACKFILED AREA TO ENSURE FULL CONTACT BETWEEN ROOTBALL AND BACKFILL -- PLACE TWO 21 GRAM FERTILIZER TABLETS FOR EACH 25mm OF TRUNK CAUPER (70mm TREE = 5 TABLETS), PLACE 30-50mm FROM TIP OF ROOTS HALFWAY UP ON BALL ROOT BALL Ø

ROOT BALL ∅ EXCAVATE SHRUB BED TO BE 2.5 TIMES WIDER THAN ROOT BALL DIAMETER

mm HIGH SOIL SAUCER BEYOND EDGE OF 100mm high. C.,
ROOT BALL
—PLANTING MIXTURE BACKFILL -TWO 21 GRAM FERTILIZER TABLETS FOR EACH SHRUB (DISTRIBUTE TABLETS EQUALLY AMONG SHRUBS IN BED), PLACE 30-50mm FROM EDGE OF ROOTS HALFWAY UP ON BALL -ROUGHEN EDGES OF PLANTING PIT TAMPED PLANTING MIXTURE AROUND BASE OF ROOT BALL . TED OR EXISTING SOIL

IT ROOTBALL ON UNEXCAVATED OR TAMPED SOIL

CROWN OF ROOT BALL FLUSH WITH F

-REMOVE ALL TWINE, ROPE, WIRE, BURLAP AND PLASTIC WRAP FROM TOP HALF OF ROOT BALL (IF PLANT IS SHIPPED WITH A WIRE BASKET AROUND THE ROOT BALL, CUT WIRE IN FOUR PLACES AND FOLD DOWN 200mm INTO PLANTING HOLE)

-70mm DEPTH AFTER SETTLEMENT, MULCH LAYER TO EDGE OF PLANTING BED. DO NO PLACE MULCH IN CONTACT WITH SHRUR

B&B SHRUB SLOPED BED PLANTING DETAIL

STAKED B&B CONIFEROUS TREE PLANTING DETAIL

-SHRUB (DO NOT PRUNE, STAKE, OR WRAF SHRUBS UNLESS DIRECTED TO DO SO BY LANDSCAPE ARCHITECT) GRADE LEAVING TRUNK FLAF THE TOP OF THE ROOT BALL REMOVE ALL TWINE, ROPE, WIRE, BURLAP AND
PLASTIC WRAP FROM TOP HALF OF ROOT BALL
(IF PLANT IS SHIPPED WITH A WIRE BASKET
AROUND THE ROOT BALL, CUT WIRE IN FOUR
PLACES AND FOLD DOWN 200mm INTO
PLANTING HOLE) -FINISH GRADE WO 21 GRAM FERTILIZER TARLETS FOR FACH , ROOT BALL Ø EXCAVATE SHRUB BED TO BE 2.5 TIMES WIDER

PROPOSED COMMERCIAL DEVELOPMENT 135 QUEEN STREET

terraplan

REVISED PER TOWN COMMENTS

REVISED PER TOWN COMMENTS

CONTRACTOR MUST VERIFY ALL DIMENSIONS ON THE JOB AND REPORT ANY DISCREPANCY TO THE LANDSCAPE ARCHITECT BEFORE PROCEEDING WITH THE MARRIE.

WORK.
ALL DRAWINGS AND SPECIFICATIONS ARE INSTRUMENTS OF SERVICE AND THE
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LANDSCAPE ARCHITECT,

FOR TOWN REVIEW

NIAGARA ON THE LAKE ONTARIO

LANDSCAPE DETAILS

EXCAVATED OR EXISTING SOIL

DRAWN: JD CHECKED: JD NTS SCALE: DATE: SEPT 2014 PROJECT NO.: 14-180

L-301



2015-03-17 JD

2015-02-19 JD

STAKED B&B CONIFEROUS TREE SLOPED PLANTING DETAIL

DOSEN SURFACE SOIL OF PLANTING HOLE

INDISTURBED SUBGRADE

B&B SHRUB BED PLANTING DETAIL

NOT FOR CONSTRUCTION

BULB PLANTING DETAIL

TAMPED PLANTING MIXTURE, SEE SOIL DEPTH CHART

WATER.
A SOIL TEST SHOULD BE PERFORMED BY A COMPETENT HYDROSEEDING CONTRACTOR TO VERIFY MIXTURE AND PERCENTAGES REQUIRED. — RAISE FINISH GRADE OF PLANTING BED 50mm FOR ADEQUATE DRAINAGE — REMOVE PLANT FROM POT - SLIGHTLY LOOSEN OR SEPERATE IF ROOT MASS IS COMPACTED. PLANT AT SAME RELATIVE ELEVATION AS ORIGINAL GRADE

PREPARATION:
GRADE SUB-GRADE, ELIMINATE UNEVEN AREAS AND LOW SPOTS,
BRINGER POSTITED DRAMAGE. REMOVE DEBRIS, ROOTS, BRANCHES,
STONES IN EXCESS OF SIMM DIAMETER AND OTHER DELETERIOUS
MATERIALS, REMOVE SUBSICIL, THAT HAS BEEN CONTAMENATED WITH
OL, GASOLINE OR CALCULO CHORDED, DISPOSE OF REMOVED
MATERIAL AS ROLLECTED BY LANGESCHE ARCHITECTS.

THE CONTRACTOR SHALL NOT CARRY OUT THE WORK UNDER ADVERSE WEATHER CONDITIONS SUCH AS HIGH WIND, FROZEN GROUND OR GROUND COVERED WITH SNOW, ICE OR STANDING WATER

AREAS TO BE SEEDED OR HYDROSEEDED SHALL RECEIVE AN APPLICATION OF SEED AT THE RATE AS SPECIFIED ON THE SEED MIXTURE DETAILS.

5-20-20 ANALYSIS 450KG 32-0-0 ANALYSIS 115KG (SULPHUR COATED AREA) 0-46-0 ANALYSIS 225KG


GRADE SUB-GRADE FOR HYDRO-SEEDING TO A UNIFORM SURFACE AND REMOVE VEGETATION WHICH MAY INTERFERE WITH SEEDING OPERATIONS, LOOSEN SOIL TO DEPTH OF 25MM MINIMUM AND REMOVE STONES AND FOREIGN MATERIAL WHICH PROTRUDE MORE THAN 75MM ABOVE THE SURFACE.

THAN 75MM ABOVE THE SURFACE.
ENSURE OPTHUM SOE MOSITURE CONTENT FOR SEED GROWTH
PRIOR TO SCARRICATION AND SEEDING.
USE 'SOIL GUARD' BONDED FIBRE MATRIX BY WEHERHAEUSER OR
SMILAR APPROVED SOIL STABILIZER FOR ALL SLOPE CONDITIONS. ALL AREAS TO BE HYDROSEEDED TO RECEIVE 300mm OF TOPSOIL.

MAINTENANCE: INJUNI ENLANCE:

SEEDED AREA TO BE MINITAINED BY CONTRACTOR ENSURING ADCULATE WATER FERTIL DER, MINITEMINE AND FERFAR WITH SEEDED AREA ARE PROPERTY SETAUSIEND. AREA SEEDED AREA ARE PROPERTY SETAUSIEND. AREA SEEDED IN FALL WILL BE ACCEPTED IN FOLLOWING SPRING, ONE MONTH AFTER START OF GROWING SEASON PROVIDED ACCEPTANCE CONDITIONS ARE FULFILLED. HYDRAULIC MULCH TO BE APPROVED BY THE LANDSCAPE ARCHITECT SHALL BE APPUED AT THE RATE OF 2100KG PER HECTARE. TO BE APPUED BY HAND HELD HOSING AND WALKING THE SITE FOR CONSISTENCY, IN ALL APPLICATIONS AFTER PLANT INSTAL

NOTE: SEED MIX AND RATE IS SUBJECT TO CHANGE. LANDSCAPE ARCHITECT TO CONFIRM TIMING, EXISTING CONDITIONS, AND SEED MIXES WITH THE TOWN OF NAGARA-ON-THE-LAKE PARKS DIVISION IN WRITING PRIOR TO SEEDING OPERATIONS.

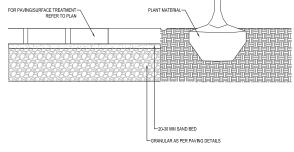

APPROVAL BY STRUCTURAL NOTE: AT ALL DRIVEWAYS, SIDEWALK SHALL BE 180MM THICK AND SLOPED TO ACCOMMODATE CURB CUTS CSW-D10

SEEDING AND HYDROSEEDING SPECIFICATIONS 3

RATE PER HECTRE:

PLANTING NEXT TO PAVED AREA

REVISED PER TOWN COMMENTS 2015-03-17 JD 2015-02-19 JD 02 REVISED PER TOWN COMMENTS 01 FOR TOWN REVIEW

CONTRACTOR MUST VERIFY ALL DIMENSIONS ON THE JOB AND REPORT ANY DISCREPANCY TO THE LANDSCAPE ARCHITECT BEFORE PROCEEDING WITH THE WORK. WORK.
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PROPOSED COMMERCIAL DEVELOPMENT 135 QUEEN STREET

NIAGARA ON THE LAKE ONTARIO

LANDSCAPE DETAILS


DRAWN: JD CHECKED: JD SCALE: NTS DATE: SEPT 2014 PROJECT NO.: 14-180




GROUND COVER PLANTING

TETTAPIAN 20 Champlain Blvd., Suite 102 Toronto, Ontario, MSH 221, Champlain Blvd., Suite 102 Toronto, Champlain Blvd., Suite 102 Toronto, Ontario, Champlain Blvd., Suite 102 Toronto, Champlain Blvd., Suite 102



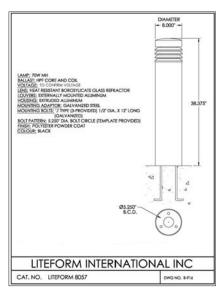

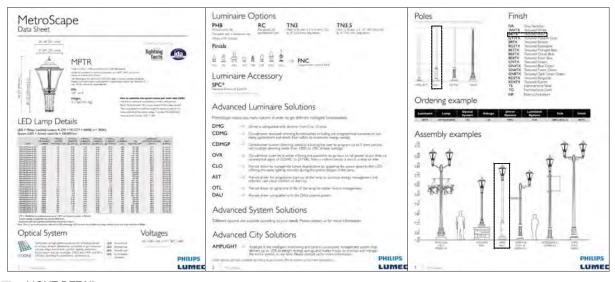

LIGHT BOLLARD

LIGHT DETAIL

Appendix B - Existing Approved

NOT FOR CONSTRUCTION

03	REVISED PER TOWN COMMENTS	2015-03-17	JD			
02	REVISED PER TOWN COMMENTS	2015-02-19	JD			
01	FOR TOWN REVIEW	2014-09-03	JD			
no.	revision	date	by			

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PROPOSED COMMERCIAL DEVELOPMENT
135 QUEEN STREET

NIAGARA ON THE LAKE ONTARIO

LANDSCAPE DETAILS

DRAWN: JD CHECKED: JD SCALE: NTS DATE: SEPT 2014 PROJECT NO.: 14-180



L-303

Appendix B - Existing Approved 5



MATERIALS: Bench frame and seat is made from H.S. stee and flat bar. The back is constructed using


FINISH: All steel components are protected with E-Coat rust proofing. The Maglin Powdercoat System provides a durable finish on all metal

INSTALLATION: The bench is delivered pre-assembled. Holes (0.5*) are provided each foot for securing to

TO SPECIFY: Select MLB400M Choose: - Style of Back (Laser cut design or H.S. ste

OPTIONS: - Personalization - Custom Laser Designs COMPLIMENTARY PRODUCTS - MLB400BM - MLWR400-20M

> STYLE - GRASS COLOUR FINISH - BLACK

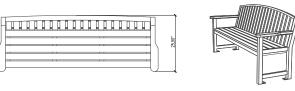

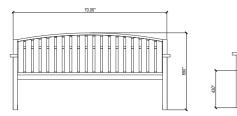




IMAGE OF FENCE TAKEN FROM 156 QUEEN STREET, NIAGARA ON THE LAKE .

NOTE: STAIN TO BE SELECTED BY LANDSCAPE ARCHITECT PRIOR TO COMPLETION. SAMPLE TO BE PROVIDED FOR APPROVAL

3

WOODEN PICKET FENCE 1070 MM HEIGHT

P-RE-QUE-27


MAGLIN MLWR 400W TRASH RECEPTACLE

E-QUE-30

BENCH DETAIL MAGLIN OR APPROVED EQUAL

MAGLIN[®]




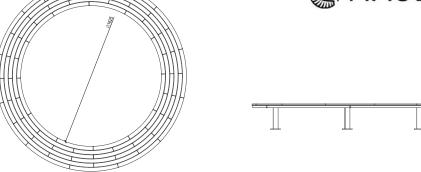

THE INFORMATION CONTAINED IN THIS DRAWING IS THE SOLE PROPERTY OF	TITLE: 100 INCH IN	ISIDE RADIUS BEI	NCH	DWG. NO. MLCB440	
MAGLIN SITE FURNITURE INC. ANY REPRODUCTION IN PART OR AS A WHOLE WITHOUT THE WRITTEN PERMISSION OF	PART NO.: MLCB440			REV.: O	APPR.: T.F.
MAGLIN SITE FURNITURE INC. IS PROHIBITED.	1:36	WEIGHT: 566.29LBS	DATE: JUL/25/2012	DRAWN BY: J. SCOTT	SHEET: 1 DF 1

CIRCULAR BENCH DETAIL MAGLIN OR APPROVED EQUAL

D DE OUE 22

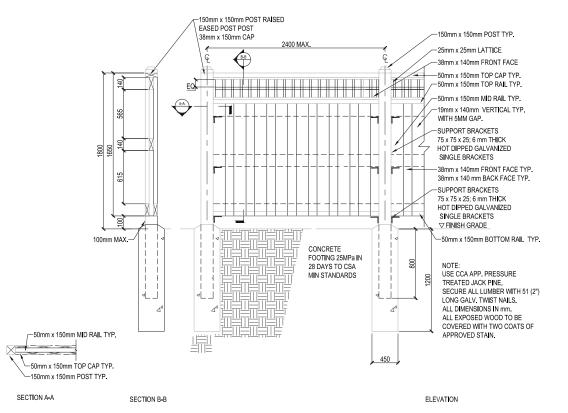

NOTE: STAIN TO BE SELECTED BY LANDSCAPE ARCHITECT PRIOR TO COMPLETION. SAMPLE TO BE PROVIDED FOR APPROVAL

5


1800 MM (6`-0") WOOD FENCE WITH LATTICE

DE OUE 25

DEVELOPMENT CORP

CLIENT

NOT FOR CONSTRUCTION

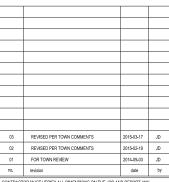

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ALL DRAWINGS TO BE USED OFF CONSTRUCTION ONLY WHEN SIGNED BY THE LANDSCAPE ARCHITECT WHICH MUST WE RETURNED AT THE WORK.

signed

terrapian Blvd., S Toronto, Onlario, All-Canda Terl (416)83 Fax:(416)838-4261

PROPOSED COMMERCIAL DEVELOPMENT
135 QUEEN STREET
NIAGARA ON THE LAKE

NIAGARA ON THE LAKE ONTARIO

LANDSCAPE DETAILS

DRAWING

DRAWN: JD

CHECKED: JD

SCALE: NTS

DATE: SEPT 2014


PROJECT NO.: 14-180


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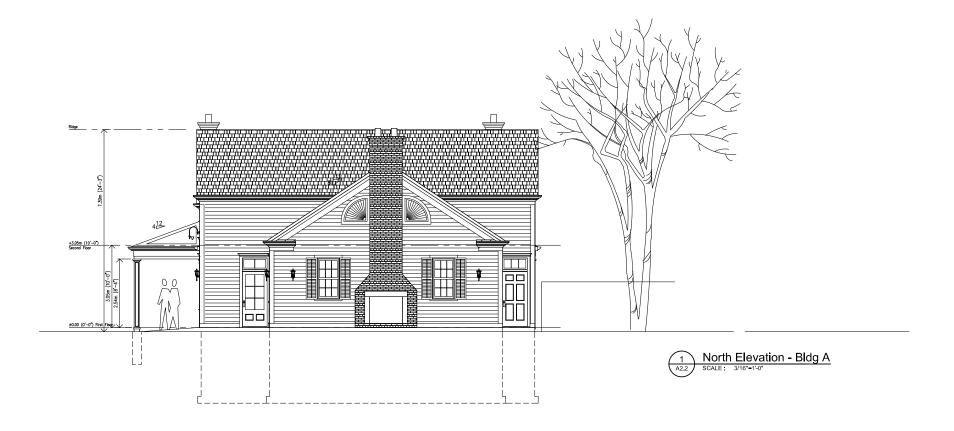





Proposed Commercial Development

135 Queen Street, NOTL

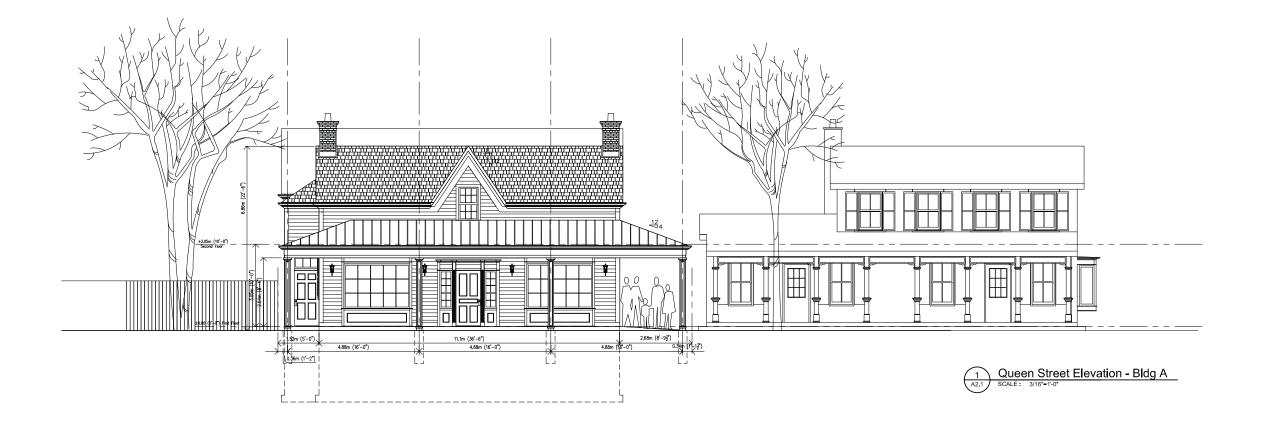Building A Elevations

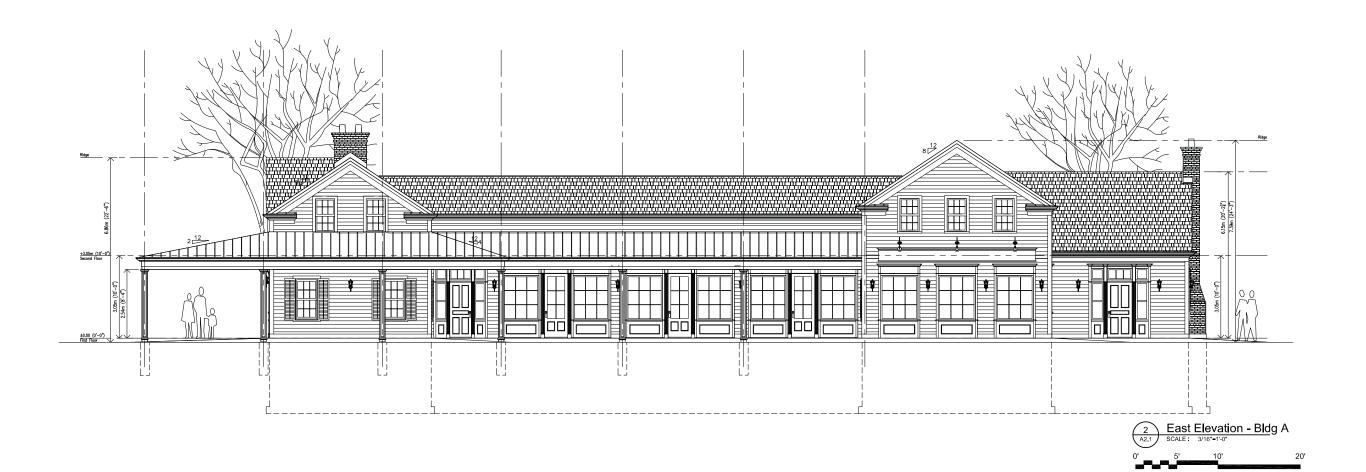

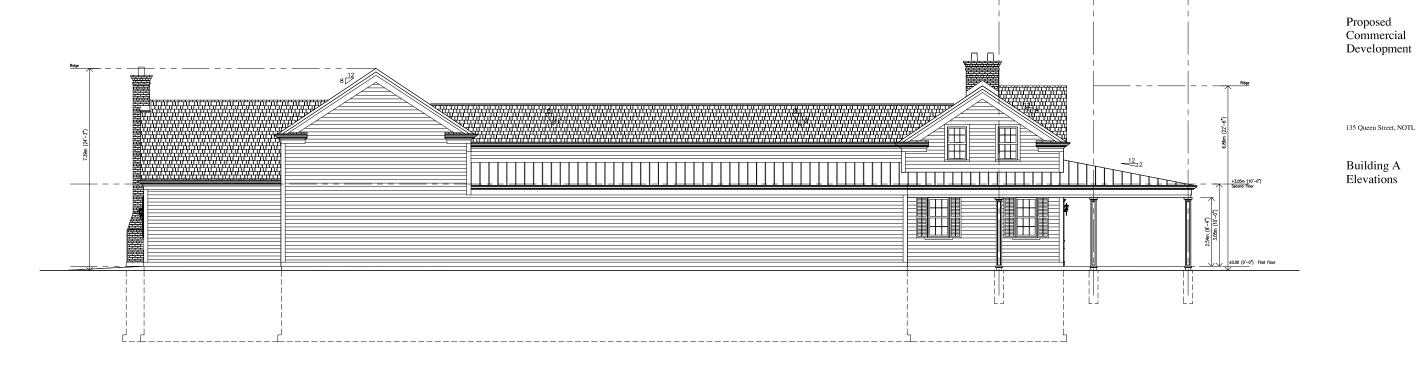

20'


West Elevation - Bldg A

SCALE: 3/16"=1'-0"







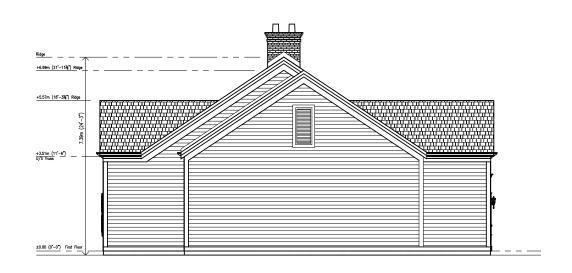


Proposed Commercial Development

135 Queen Street, NOTL

Building B Elevations





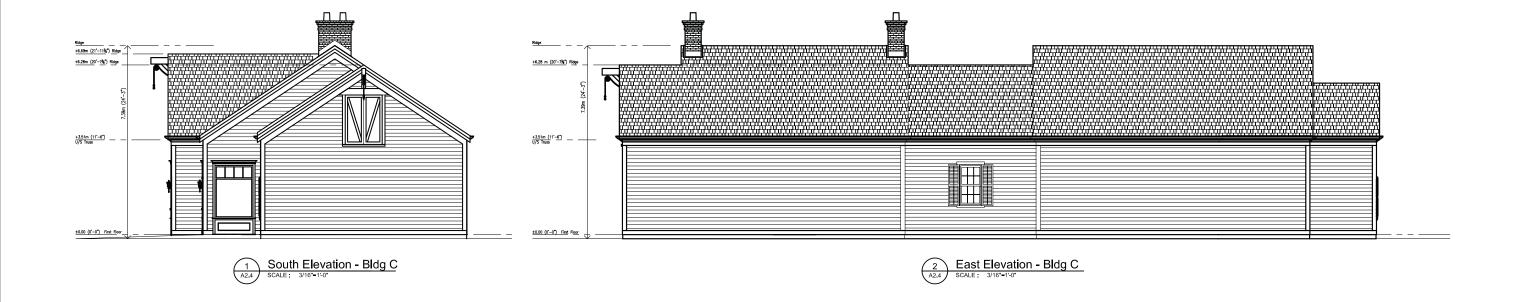

Proposed Commercial Development






135 Queen Street, NOTL
Building C

Elevations





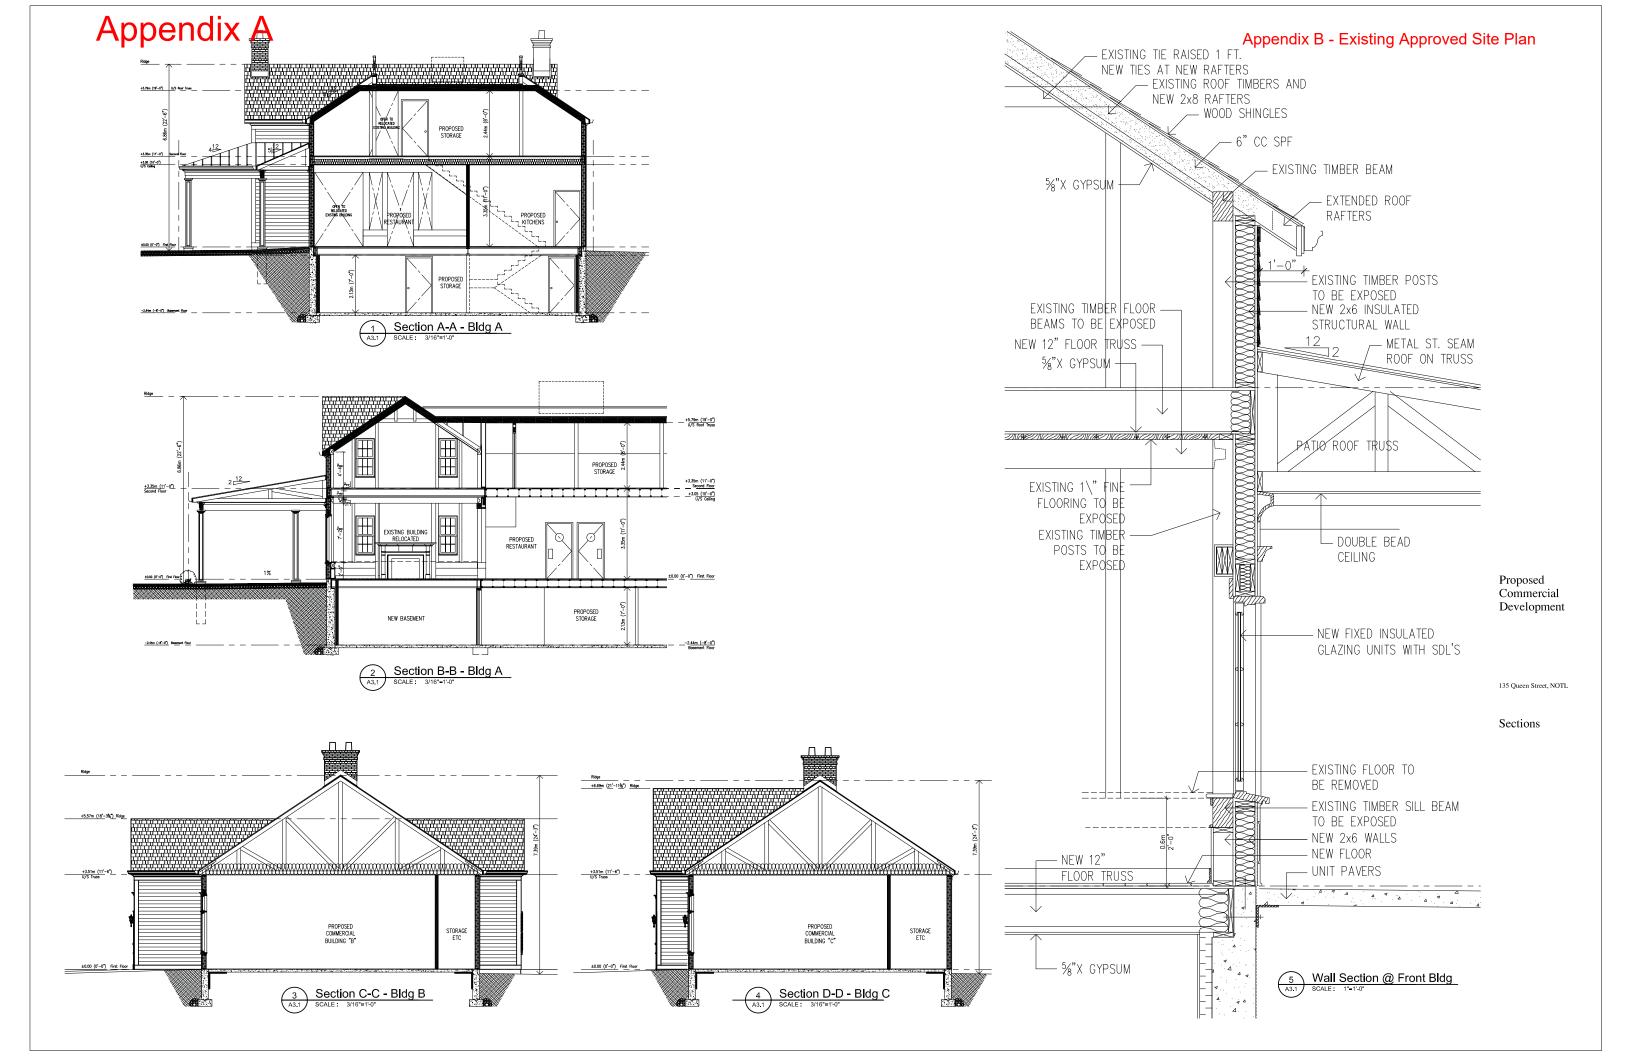



Denise,

Hope all is well. As always, it was great to see you and to offer personal congratulations!

Thank you again for tabling our Project on the Agenda the other evening. I believe it was a productive discussion with Committee and I truly wanted Members to have a clear picture of what has transpired since it has literally been years of processing.

As noted in your Report and promised, below is an email correspondence from the Ministry of Tourism, Culture and Sport.

The email advises their Archeological requirements for the site along with their support for the mitigation measures we have agreed upon (e.g. servicing via Gate and merging the structures).

Of course, notwithstanding the Ministry's requirements, we remain committed to addressing some of the design concerns raised by yourself and Committee.

This includes the front patio roof and trying to 'break up' the massing wherever possible.

I understand you will be sending along some formal comments, by Committee. Hopefully we can receive these shortly as I would like to file the Site Plan Amendment Application and return to Committee as soon as we can; in line with the ongoing Stage 4 Assessment work being undertaken.

I trust the below written confirmation is helpful and I will be sure to include this in our formal Application Submission.

Thanks Again,

Maurizio

From: Horne, Malcolm (MTCS) [mailto:Malcolm.Horne@ontario.ca]

Sent: Thursday, October 12, 2017 2:49 PM

To: Maurizio Rogato **Cc:** Archaeology (MTCS)

Subject: Advice re 135 Queen Street and the Cassady (AhGs-381) Site, Niagara-on-the-Lake, MTCS File

0001712

Hi, Maurizio. Thanks for forwarding the drawings and for providing further information by telephone. I have looked over the two attachments and I do not see anything of concern with the revised Site Plan in regard to the archaeological site or in regard to carrying out the archaeological assessment. As you note, the risk to the archaeological site and the degree of impacts will be reduced by bringing in servicing from the adjacent lands fronting Gate Street and amalgamating the previous three structures into one structure, as opposed to bring in servicing from Queen Street or having three separate structures which would create the need for more restroom facilities and associated service trenches throughout the archeological site. The amended Site Plan will then further reduce the need for trenching for plumbing services within the subject property and consequently reduce the need for impacts to the archaeological site. This aligns with the ministry's position in support of long-term protection of archaeological sites as opposed to excavation.

The Stage 4 strategy for the Cassady (AhGs-381) archaeological site was developed on the basis of a detailed Stage 3 archaeological assessment. This Stage 4 strategy was developed through extended and detailed negotiations with you, a licensed consultant archaeologist, and this ministry. The work plan and long-term protection strategy is

described in detail in the quoted report recommendations in the attached letter that entered the Stage 3 assessment report into the Register. The letter indicates our support and approval of the Stage 4 strategy.

We are aware that you have retained an archaeological consulting company, Archeoworks Inc., to carry out the Stage 4 strategy and mitigation of impacts. They have submitted the appropriate Project Information Form under licence. They have discussed the project and obtained our advice regarding various aspects of the required Stage 4 work. As part of obtaining that advice, they have informed us regarding the progress of that work and we are satisfied with that progress to date.

The Stage 4 strategy involves an unusual and creative strategy for addressing the impacts to the archaeological site. We appreciate the efforts that you and the proponent have made to address concerns for the archaeological site and to develop a strategy that will minimize the impacts to the archaeological site while still allowing the project to go forward. The Stage 4 strategy will result in appropriate archaeological excavation and documentation for the minimum degree of impacts. Impacts have been reduced by placing the minimum number of concrete pillars at select locations that will support a platform on which the structure can be supported over the archaeological site.

We will be pleased to provide further advice as the Stage 4 work progresses and to expedite the review of reporting as requested.

Please don't hesitate to contact me further regarding this project.

Sincerely,

Malcolm Horne
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[attachment "ENTERED INTO REGISTER_ Archaeological Report for P302-0075-2015.pdf" deleted by Denise Horne/TownOfNiagara/CA] [attachment "AD1.0.pdf" deleted by Denise Horne/TownOfNiagara/CA] [attachment "15625 2016.10.31 AD0.pdf" deleted by Denise Horne/TownOfNiagara/CA]

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