
LC

BCIN

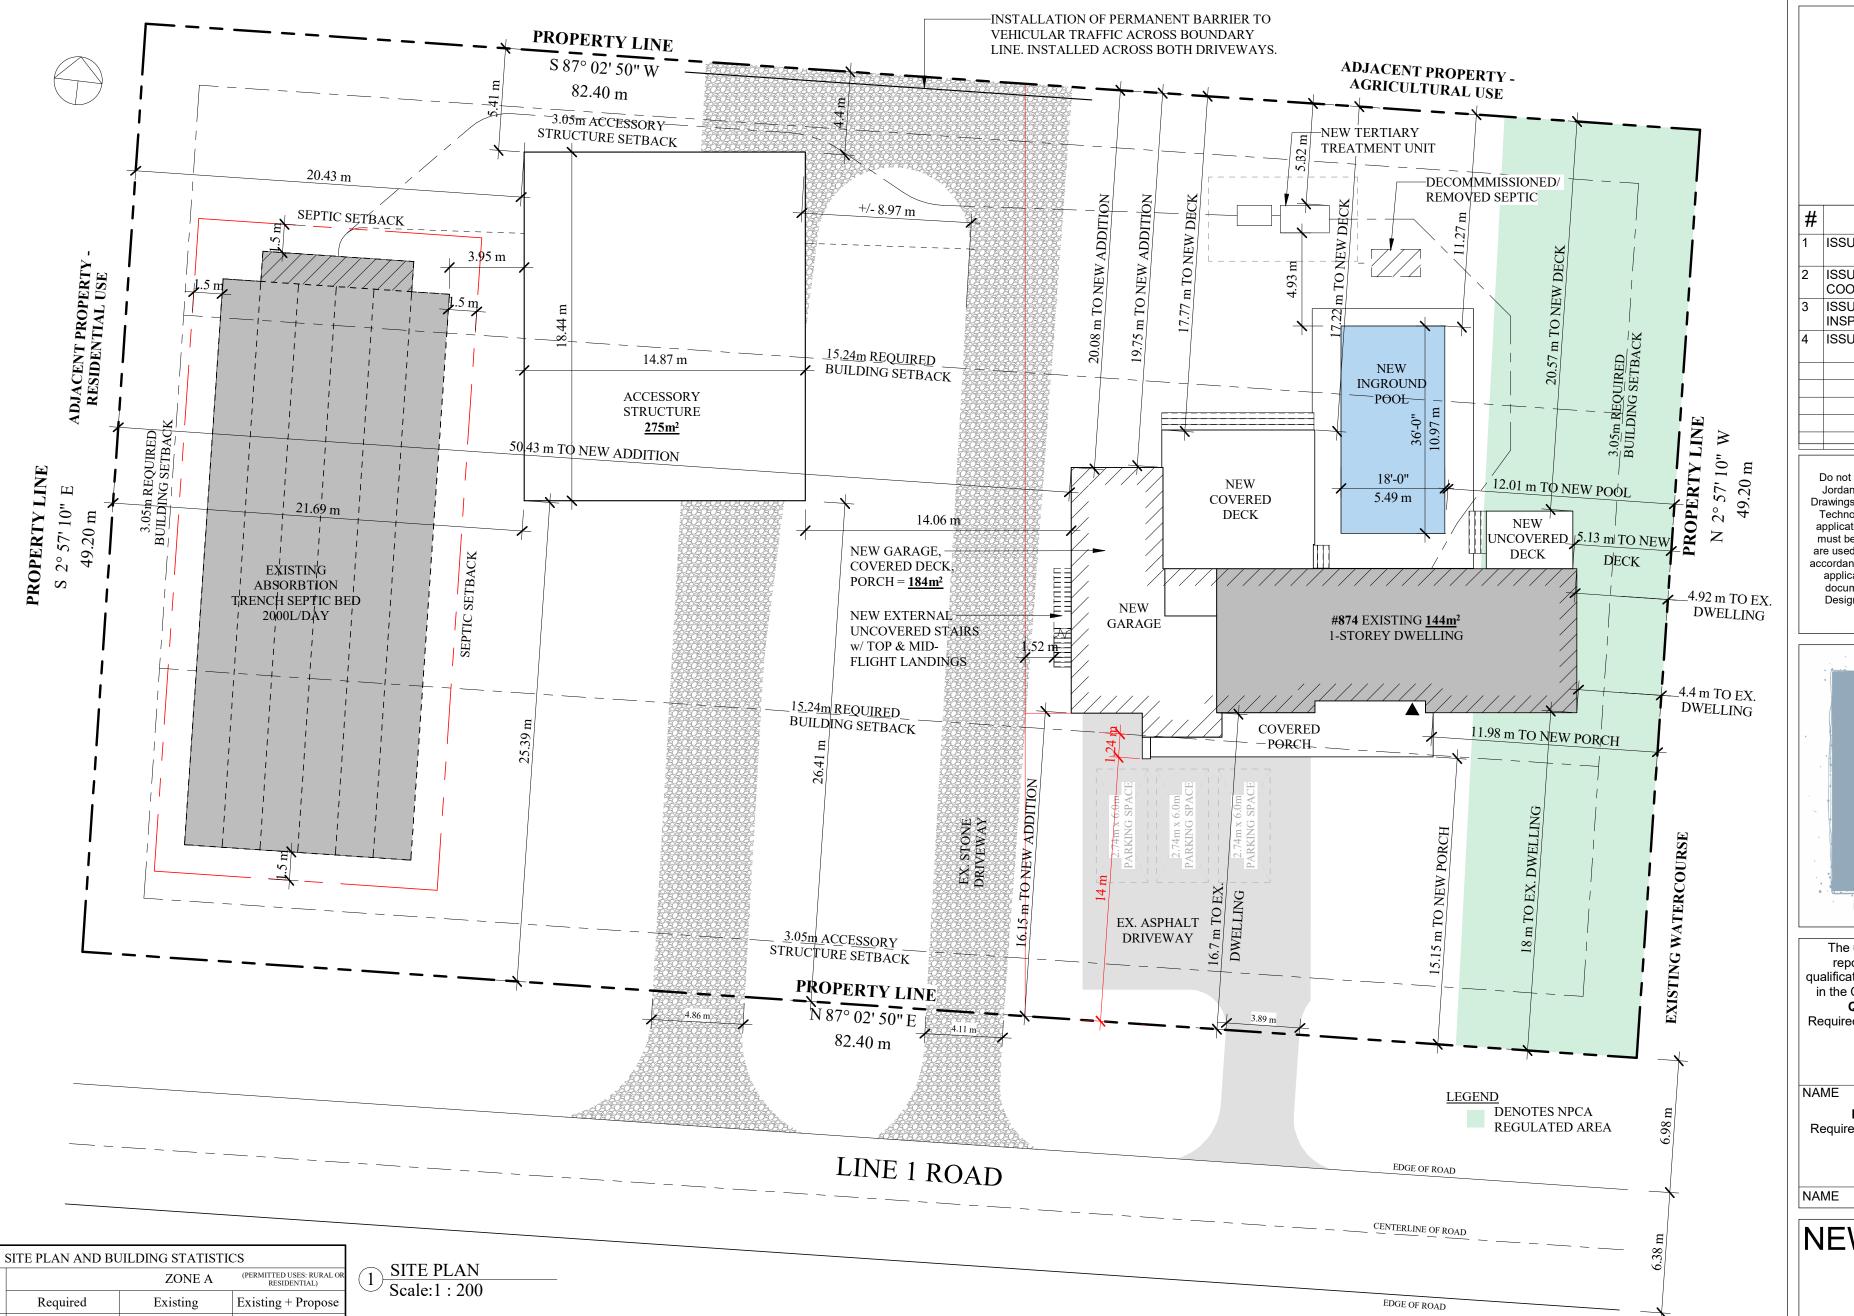

SHE PLAN AND BUILDING STATISTICS					
Zoning:			(PERMITTED USES: RURAL OR RESIDENTIAL)		
	Required	Existing	Existing + Propose		
Lot Area	3716 sq.m.	4054.1 sq.m.	4054.1 sq.m.		
Lot Frontage	60.96 m	82.4 m	82.4 m		
Lot Coverage M	AX15% (557.4 sq.m.) MAX 8%(Accessory Structure)	3.55% 144sq.m.	14.87% 603sq.m. 6.8%(Accessory Structure)		
Front Setback	(3.05m Accessory Structure & Pool) 15.24m	SEE SITE	DWELLING: 14.0m ACCESS. BLDG: 25.39m		
Rear Setback	(3.05m Accessory1 5.24m Structure & Pool)	SEE SITE	SEE SITE		
Int.Side Setback	(3.05m Accessory Structure & Pool) 3.05m	SEE SITE	SEE SITE		
Ex. Side Setback	N/A	N/A	N/A		
Building Height	(4.5m Accessory 10.67m Structure)	3.74m	6.375m Accessory Structure TBD HOUSE		
Landscaped	N/A	N/A	N/A		
Parking Req'd	(N/A Accessory Structure) 1	(EXISTING CAN ACCOMODATE MORE 1 THAN REQUIRED)	(PROPOSE CAN ACCOMODATE MORE 6+ THAN REOUIRED)		
Additional Requirements:	GROUND SWIMMING I SHALL COMPLY WITH	OR REAR YARD REQUIR POOLS AND ABOVE GRO THE ACCESSORY BUILD THE ZONE IN WHICH THE	EMENTS FOR IN- UND SWIMMING POOLS VING YARD		

MINIMUM LOT DEPTH: REQUIRED 60.96m, EXISTING 49.2m

HEIGHT MEANS: (a) IN THE CASE OF A FLAT ROOF, THE HIGHEST POINT OF THE ROOF SURFACE OR THE PARAPET, WHICHEVER IS THE GREATER

(b) IN THE CASE OF A MANSARD ROOF, THE DECK ROOF LINE, AND

(c) IN THE CASE OF A GABLE, HIP, OR GAMBREL ROOF, THE MEAN HEIGHT BETWEEN THE EAVES AND RIDGE

LOT COVERAGE: MEANS THE PERCENTAGE OF THE LOT AREA COVERED BY BUILDINGS, INCLUDING ACCESSORY BUILDINGS, BAY/CANTILEVERED WINDOWS, COVERED PORCHES AND VERANDAS, COVERED DECKS AND COVERED ENTRANCE WAYS BUT NOT INCLUDING AN IN-GROUND OR ABOVE GROUND SWIMMING POOL, A SATELLITE DISH, UNCOVERED PARKING AREAS OR DRIVEWAYS

#	Description	Date
1	ISSUED FOR COORDINATION	27MAY2 024
2	ISSUED FOR MINOR VARIANCE COORDINATION	19JUL2 024
3	ISSUED FOR SEPTIC INSPECTION	08AUG2 024
4	ISSUED FOR MINOR VARIANCE	17JAN2 024

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SIGNATURE

REGISTRATION INFORMATION Required unless design is exempt under 3.2.4.1

SIGNATURE NAME

NEW ACCESSORY BUILDING

874 Line 1 Road, Niagara-on-the-Lake, ON, L0S 1J0


SITE PLAN


Project number 23086 FEBRUARY 2025 Drawn by GAC & NW Designed by

A1-1

Scale


1:200

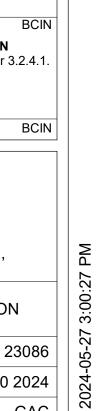

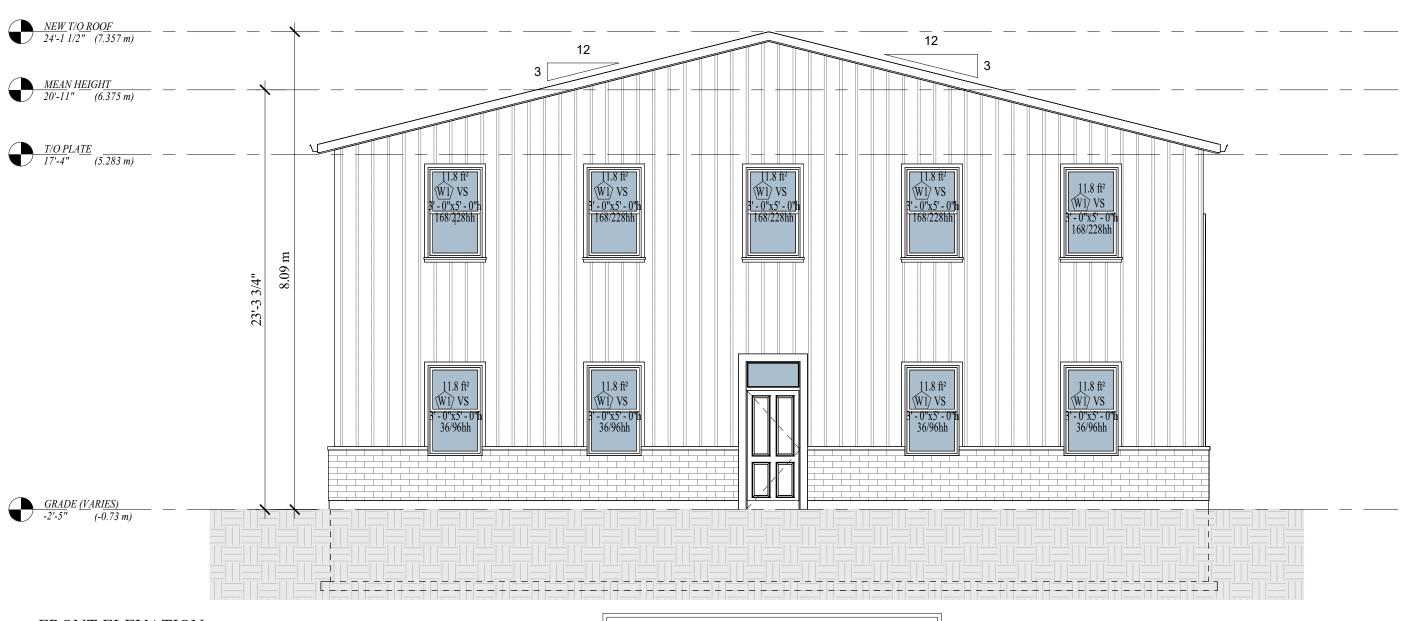

1 FRONT ELEVATION Scale: 3/16" = 1'-0"

EXPOSED BUILDING FACE (OBC TABLE 9.10.15.4.)				
Limiting Distance:		19.31m		
Area Exposed Face:		88 sq.m.		
Allowable Area:	100%	88 sq.m.		
Proposed Area:	10 sq.m.	11.36%		

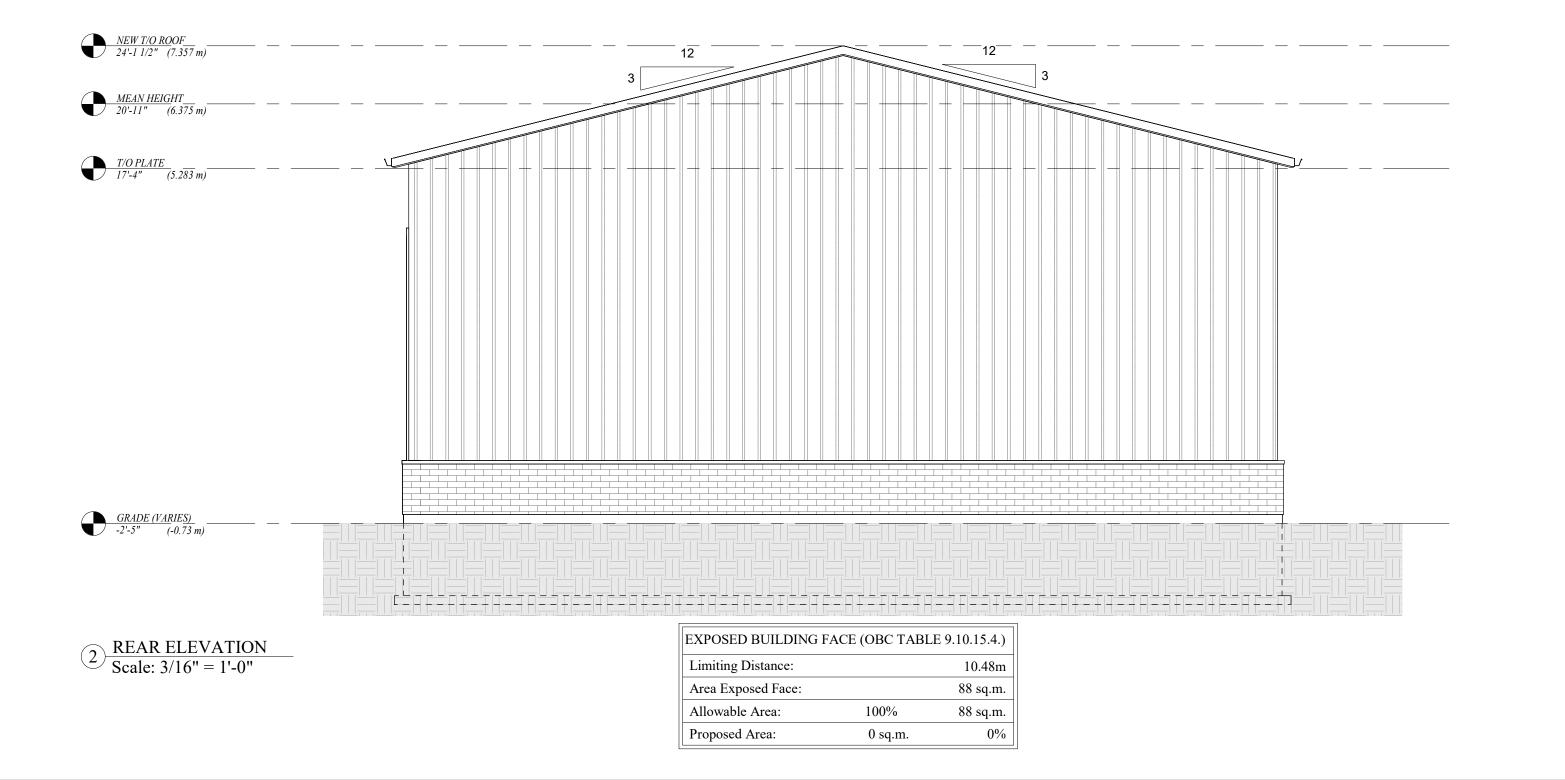

PRELIMINARY NOT FOR CONSTRUCTION

#	Description	Date
1	ISSUED FOR COORDINATION	27MAY2 024

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of the Ontario Building Code

NAME SIGNATURE BO

REGISTRATION INFORMATION

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NAME

SIGNATURE

NEW FARM BUILDING


874 Line 1 Road, Niagara-on-the-Lake, ON, L0S 1J0

FRONT & REAR ELEVATION

Project number	23086
Date	April 30 2024
Drawn by	GAC
Designed by	LC

A2-1

Scale 3/16" = 1'-0"

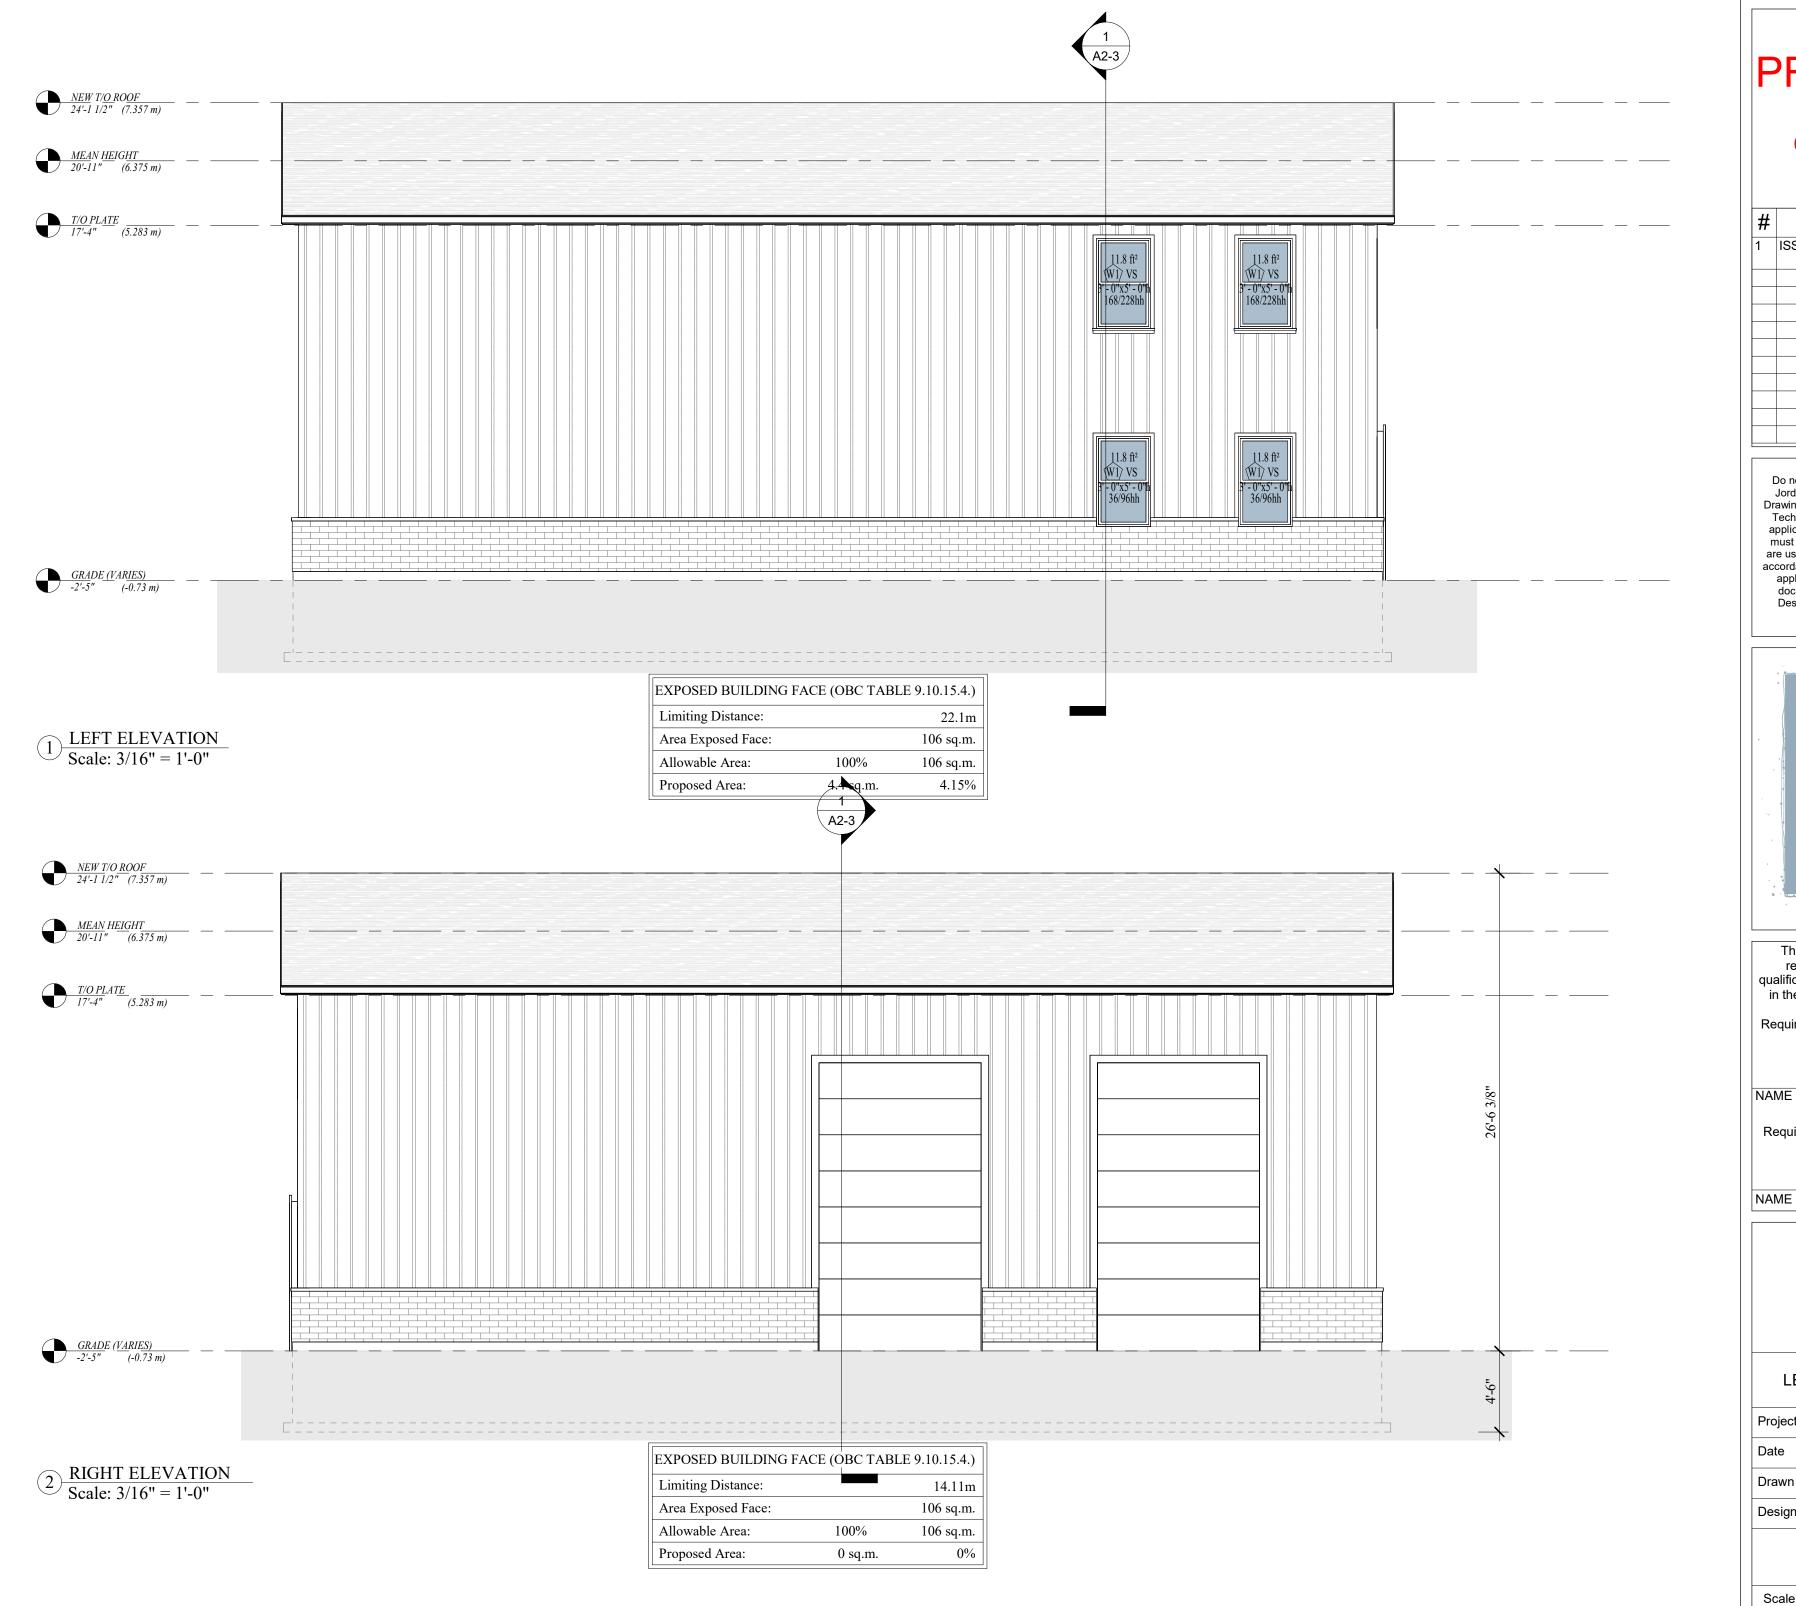

PRELIMINARY NOT FOR **CONSTRUCTION**

#	Description	Date
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NEW FARM BUILDING

874 Line 1 Road, Niagara-on-the-Lake, ON, L0S 1J0

LEFT AND RIGHT ELEVATION

Project number	23086
Date	April 30 2024
Drawn by	GAC
Designed by	LC

A2-2

3/16" = 1'-0" Scale

BCIN

BCIN

LC

BCIN

LIGHT FIXTURE (CEILING MOUNTED)

LIGHT FIXTURE (WALL MOUNTED)

RAIN WATER LEADER

LOCATION OF RAIN WATER LEADER TO TERMINATE AT SPLASH PAD IN STC OR STORM WATER DRAIN. RULE OF THUMB: DOWNSPOUT SIZING 1SQIN=100SQFT R.O.T.

CONCRETE FOUNDATION WALL (20MPA) -8" POURED CONCRETE FOUNDATION

WALL -24" WIDE BY 8" DEEP FOOTING 4'-0" BELOW GRADE & RESTING ON UNDISTURBED

SIDING WALL WITH BRICK BASE

-BRICK VENEER AT BASE AND BOARD AND BATTEN ON THE UPPER PORTION -1" AIR SPACE FOR BASE VENEER -AIR BARRIER -1" (R5) RIGID BOARD -7/16" OSB WALL SHEATHING -2-2X6 SPF NO.1 OR 2 WOOD STUD @ 16" o/c W/ R19 BATT INSULATION -6 mil. VAPOUR BARRIER -1/2" GYPSUM BOARD

SLAB ON GRADE -5" THICK CONCR. SLAB (32 MPa) W/ 5-8%

AIR ENTRAINMENT -2" (R10) RIGID INSULATION -6" GRAVEL BASE OF 3/4" CLEAR CRUSHED STONE -OPTIONAL 6"x6" x6/6" WMM REINFORCING WITHIN SLAB

(F1)

TRUSS ROOF -ASPHALT SHINGLES -ICE & WATER SHIELD @ EAVES & VALLEY -FELT PAPER UNDERLAYMENT -5/8" T&G OSB SHEATHING -PRE-ENG TRUSSES -R60 BATT INSULATION -6 mil POLY VAPOUR BARRIER -1/2" GYPSUM BOARD


STRUCTURAL LEGEND:

NAILING AS PER OBC REQUIREMENTS UNLESS NOTED OTHERWISE BY **ENGINEER**

CLIMATIC DESIGN:

DESIGN SNOW LOAD 1.5kpa Hourly Wind Pressure 1/10: 0.33kpa Hourly Wind Pressure 1/50: 0.43kpa

L1 2 - 2"x 8" SPF #2 L2 2 - 2"x10" SPF #2 L3 2 - 2"x12" SPF #2

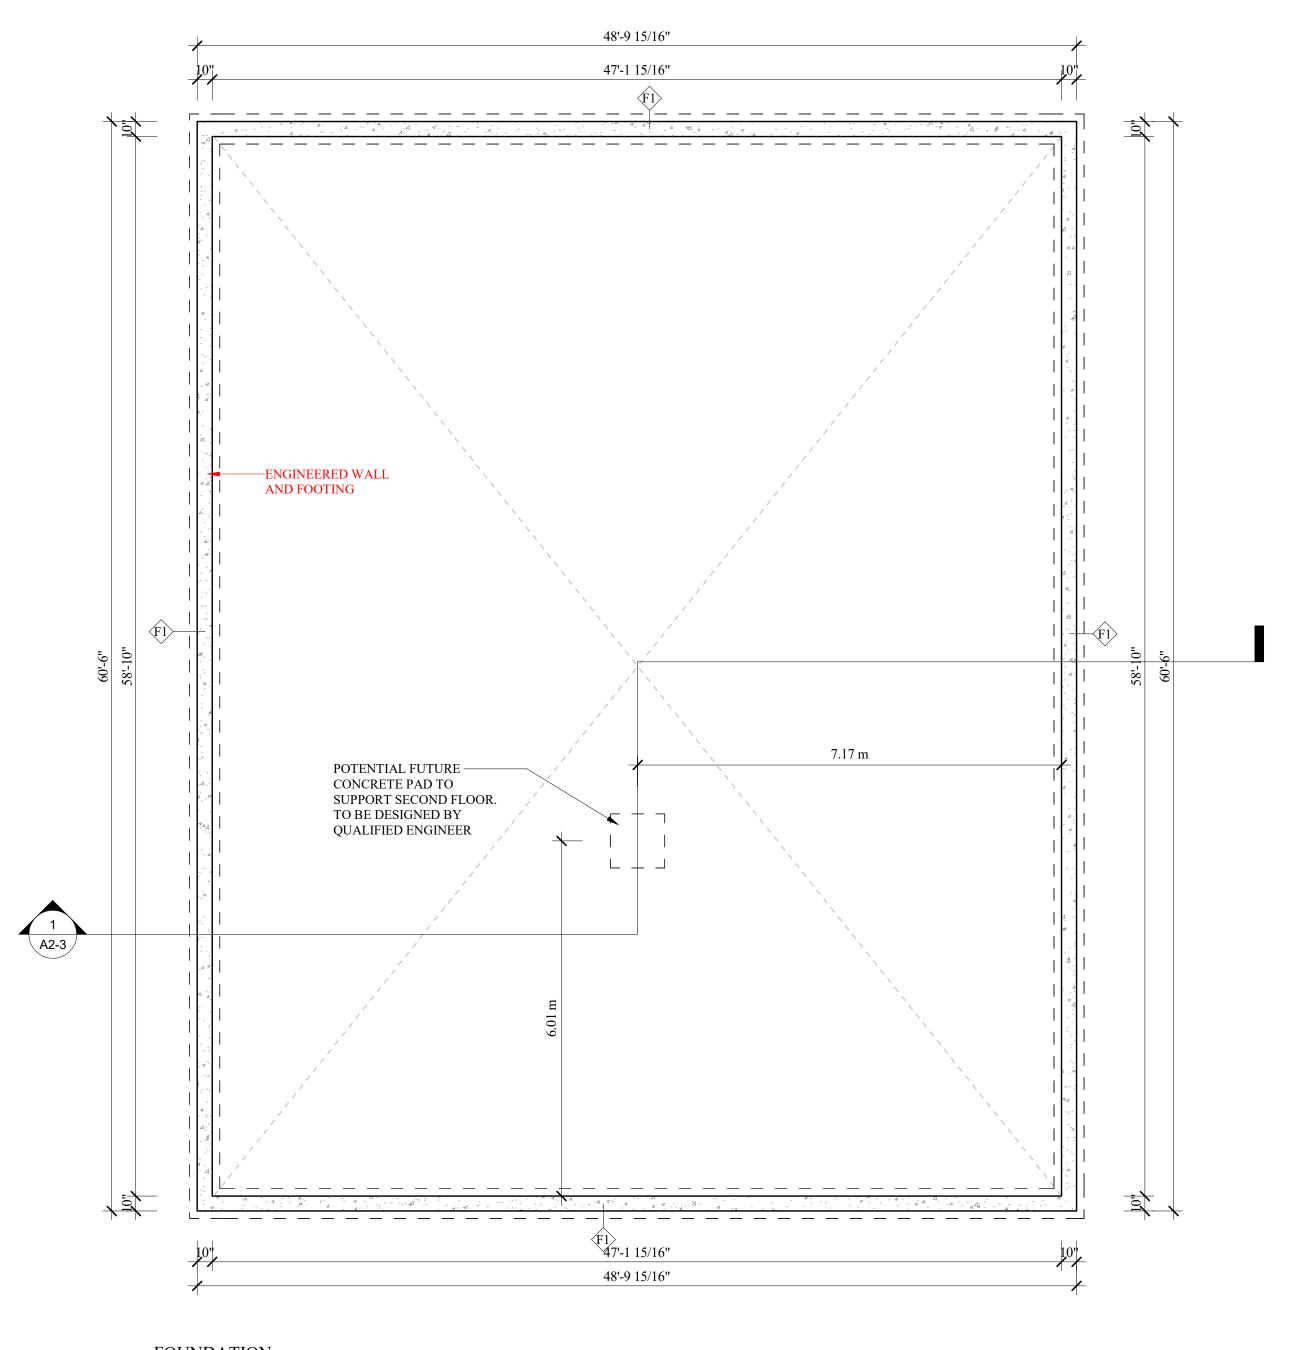

FOUNDATION Scale: 3/16'' = 1'-0''

Date Description ISSUED FOR COORDINATION 27MAY2 ISSUED FOR SEPTIC 08AUG2 INSPECTION 024 4 ISSUED FOR MINOR VARIANCE 17JAN2

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NAME

Designed by

SIGNATURE

NEW ACCESSORY BUILDING


874 Line 1 Road, Niagara-on-the-Lake, ON, L0S 1J0

FOUNDATION PLAN

Project number 23086 FEBRUARY 2025 GAC Drawn by

A1-2

Scale As indicated

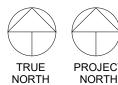

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1	ISSUED FOR COORDINATION	27MAY2 024
3	ISSUED FOR SEPTIC INSPECTION	08AUG2 024
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NEW ACCESSORY BUILDING

874 Line 1 Road, Niagara-on-the-Lake, ON, L0S 1J0

GROUND FLOOR PLAN

23086 Project number FEBRUARY 2025

GAC Drawn by Designed by

A1-3

Scale As indicated

BCIN


LC




2024-05-22 3:58:02 PM

WINDOW SCHEDULE				
Type Mark	Count	Width	Height	Window Type
W1	1	7'-4"	5'-11"	GP
W2	2	5'-0"	5'-0"	GP
W3	1	5'-5"	6'-9"	GP
W4	3	5'-0"	4'-0"	GP
W5	1	2'-3"	5'-3"	FX
W6	2	2'-1"	5'-11"	GP
W7	1	4'-8"	5'-11"	GP
W8	1	5'-5"	5'-11"	GP
W9	2	5'-5"	5'-1"	GP

DOOR SCHEDULE					
Type Mark	Count	Width	Height		
D1	1	2'-10"	7'-9"		
D2	5	2'-10"	8'-3"		
D3	1	9'-0"	7'-0"		

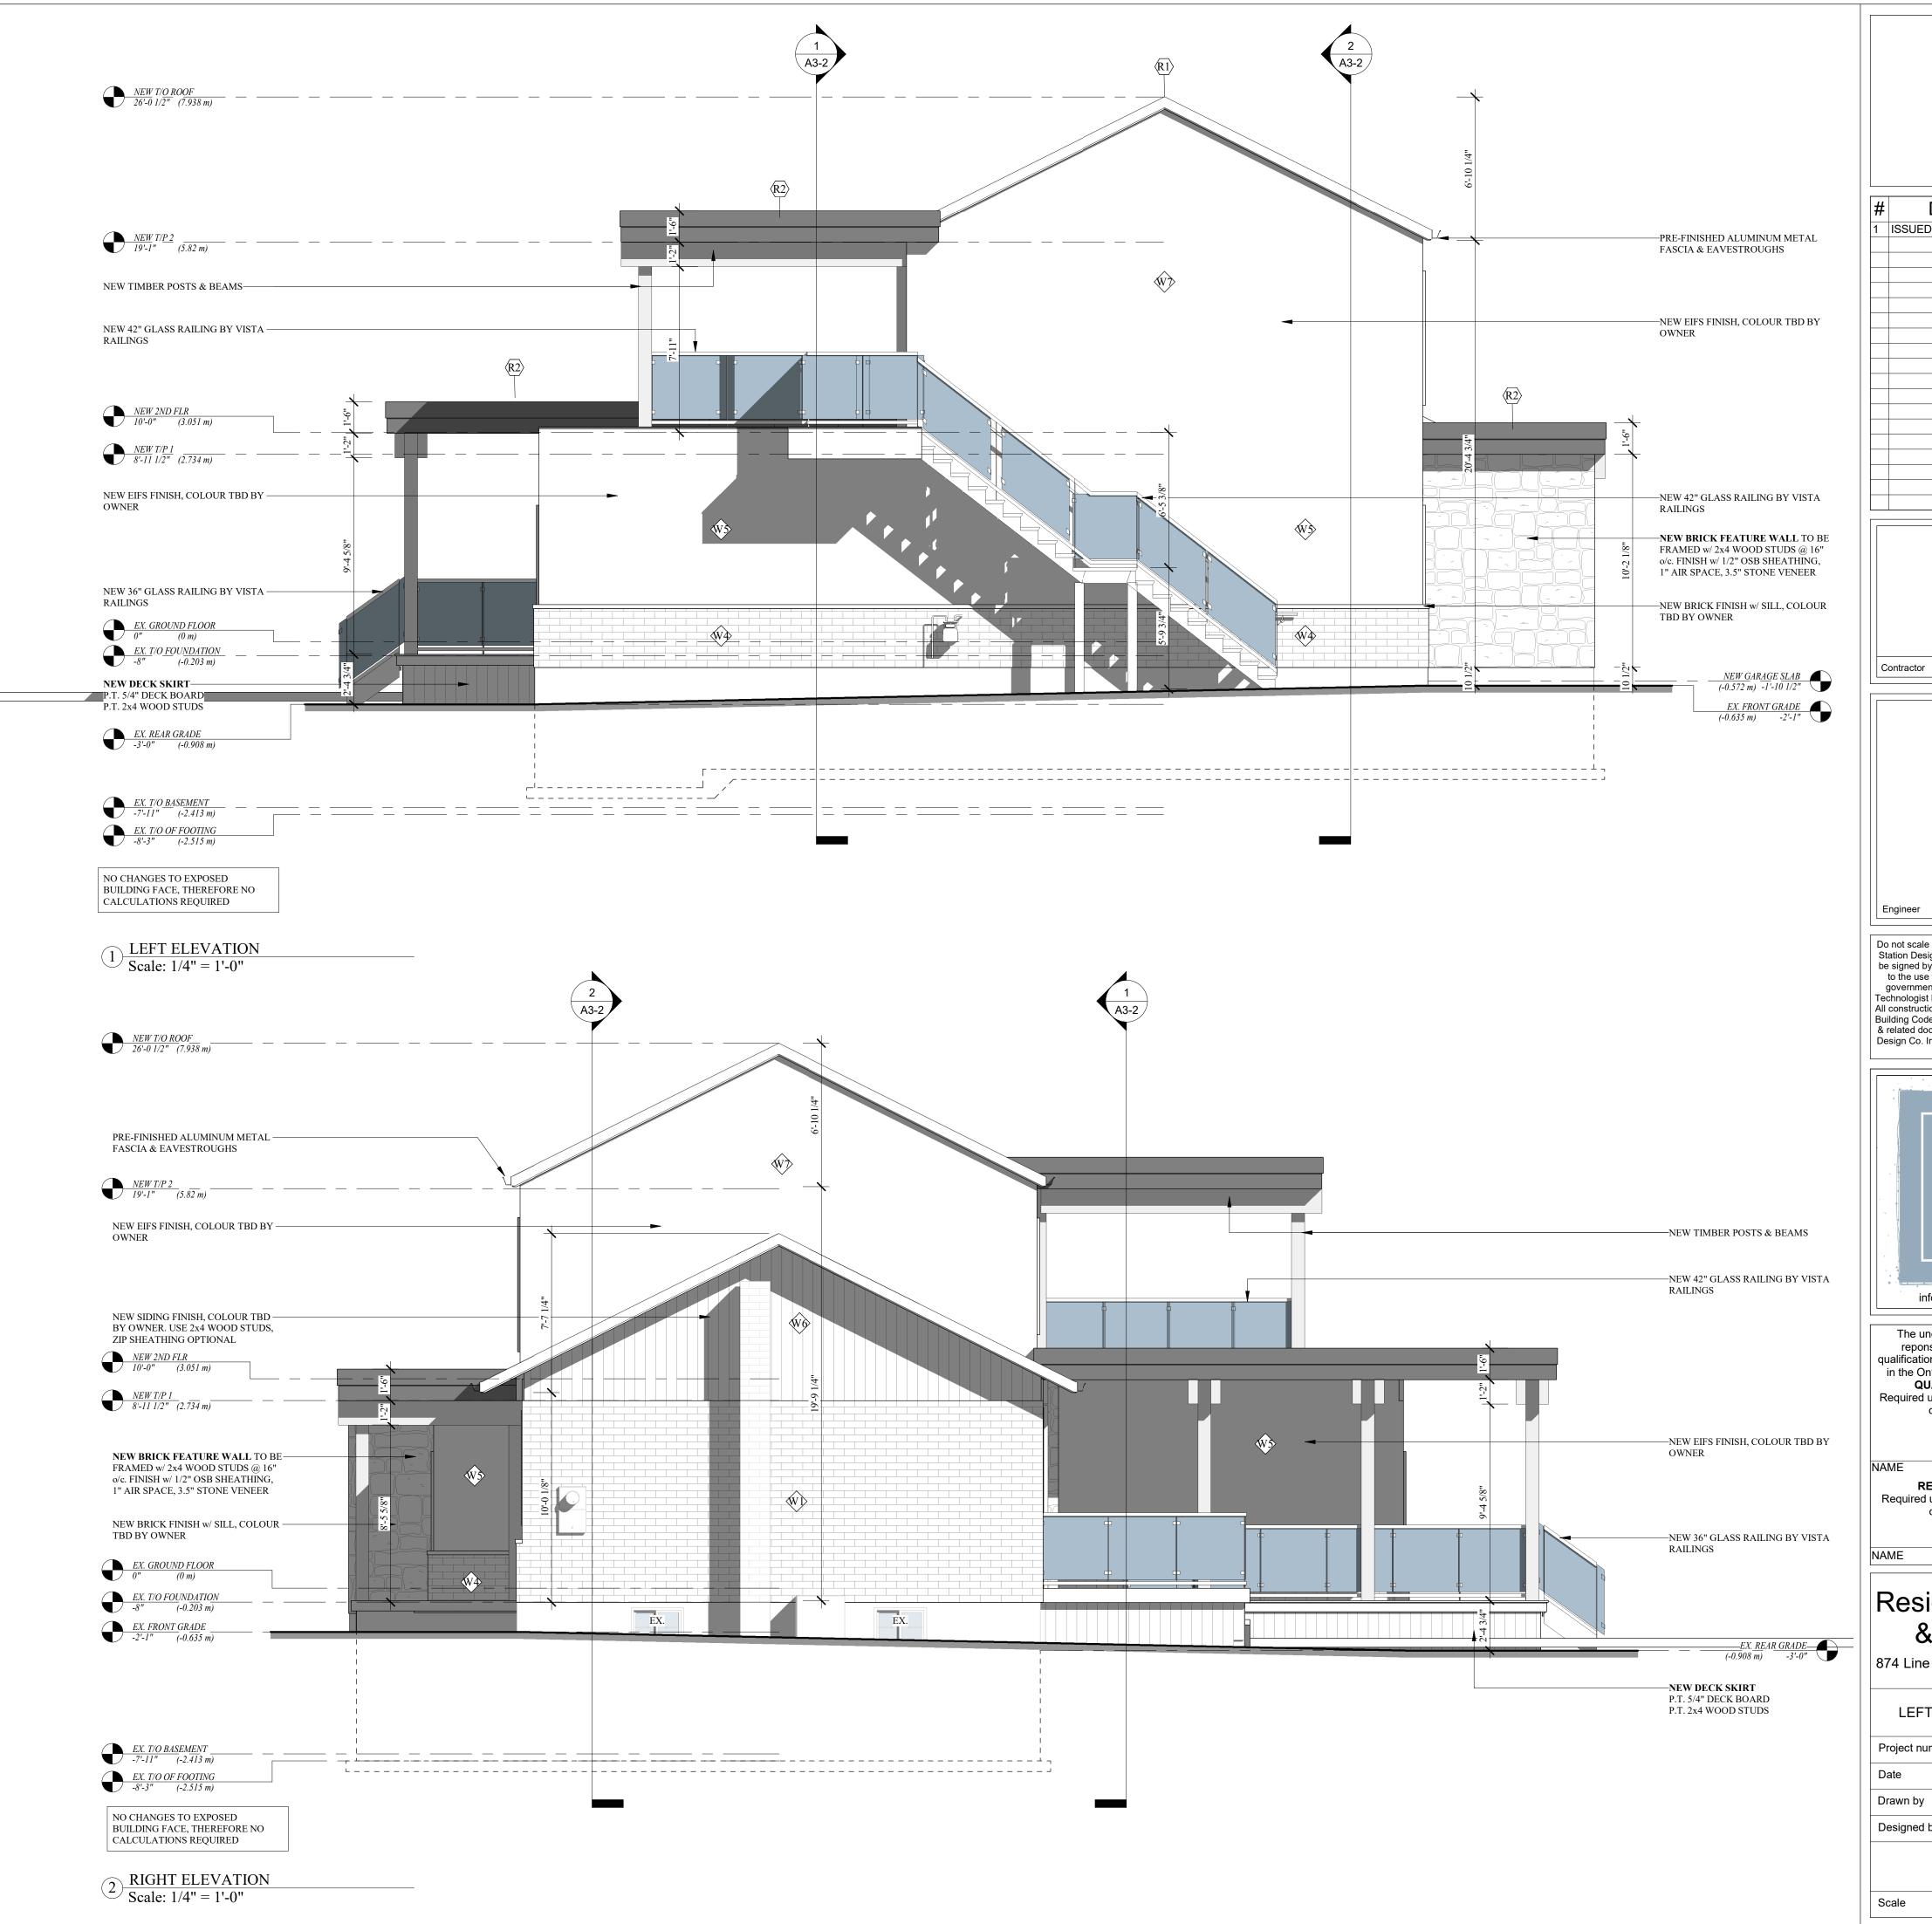

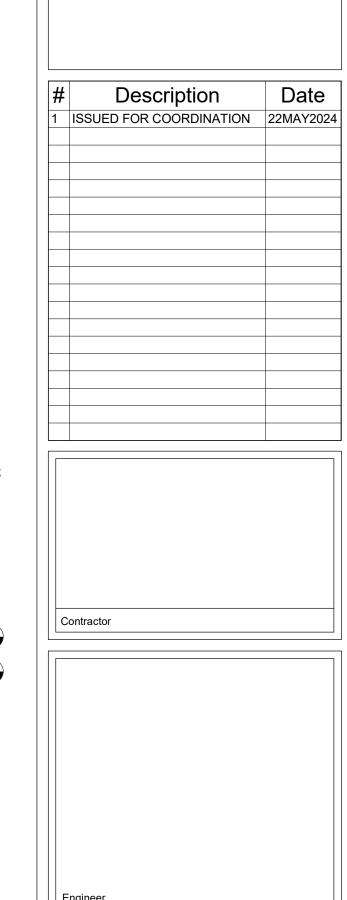

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of the Ontario Building Code

NAME SIGNATURE BCIN

REGISTRATION INFORMATION

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of the Ontarior Building Code

NAME SIGNATURE

Residential Addition & Renovation

874 Line 1 Road, Niagara-on-the-Lake, ON, L0S 1J0

LEFT AND RIGHT ELEVATION

Project number 23086 S

Date TBD

Drawn by NW

Designed by LC

A2-2

1/4" = 1'-0"